

# 268 PARROTT STREET SAN LEANDRO, CA



## Architecture Planning Interiors


444 Spear Street, Suite 105 San Francisco, CA 94105 www.hunthalejones.com

> t. 415-512-1300 f. 415-288-0288

DETAILS

SCALE: N.T.S.
DATE: 01.03.2019
PROJECT: 335006

#### MATERIAL BOARD LOCATION MATERIAL MANUFACTURER / LINE FINISH & STYLE COLOR COMMENTS WALLS: RESIDENTIAL SHERWIN WILLIAMS - EIDER WHITE, SW 7014 LIGHT DASH 3 COAT STUCCO SYSTEM RESIDENTIAL DECKS JAMES HARDIE / ARTISAN 5" SMOOTH LAP SIDING JAMES HARDIE - TIMBER BARK LIMESTONE HONED DALTILE - CARLTON BEIGE, #L012 RESIDENTIAL ENTRY DALTILE / CENTER CITY 8"x24" W/ 1/16" GROUT JOINT COMMERCIAL MARBLE SURROUND DALTILE / CENTER CITY HONED DALTILE - DELANCEY GREY, #M322 4"x12" W/ 1/16" GROUT JOINT RANDOM INTERLOCKING MOSAIC WAINSCOT GLASS DALTILE - SOFT CASHMERE, #CW22 DALTILE / COLOR WAVE 12"x18" SHEETS BLENDS DOORS AND WINDOWS: RESIDENTIAL MILGARD / T.B.D. MILGARD - ESPRESSO WINDOWS ALUMINUM OR VINYL DECK DOORS MILGARD / T.B.D. ALUMINUM OR VINYL MILGARD - ESPRESSO KAWNEER OR APPROVED EQ. / TRIFAB 601 SERIES ANODIZED BRONZE ALUMINUM RESIDENTIAL ENTRY ALUMINUM KAWNEER - MEDIUM BRONZE #28 METAL SHERWIN WILLIAMS - TURKISH COFFEE, SW 6076 GARAGE DOOR SEE DESIGN PAINTED METAL COMMERCIAL WINDOWS ALUMINUM KAWNEER OR APPROVED EQ. / TRIFAB 601 SERIES ANODIZED BRONZE ALUMINUM KAWNEER - MEDIUM BRONZE #28 10. DOORS ALUMINUM KAWNEER OR APPROVED EQ. / TRIFAB 601 SERIES KAWNEER - MEDIUM BRONZE #28 ANODIZED BRONZE ALUMINUM 11. 12. GLASS WALL ALUMINUM MILGARD / MOVING GLASS WALL SYSTEMS STACKING GLASS WALLS MILGARD - ESPRESSO SERVICE DOORS METAL T.B.D. FLUSH DOOR PAINT TO MATCH SURROUNDING WALL ACCESSORIES: SHERWIN WILLIAMS - TURKISH COFFEE, SW 6076 METAL T.B.D. RAILINGS PAINTED METAL FASCIA 24 GA. STEEL PETERSEN ALUMINUM / PAC-TITE WT FASCIA ANODIZED ALUMINUM 15. PETERSEN - MEDIUM BRONZE COPING 16. 24 GA. STEEL PETERSEN ALUMINUM / PAC-TITE TAPED COPING ANODIZED ALUMINUM PETERSEN - MEDIUM BRONZE CORNICE METAL SHERWIN WILLIAMS - TURKISH COFFEE, SW 6076 SEE DETAIL PAINTED METAL ROOF: WHITE SYSTEM TPO FIRESTONE OR EQ. COOL ROOF

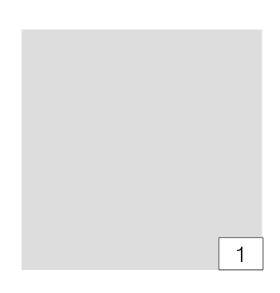














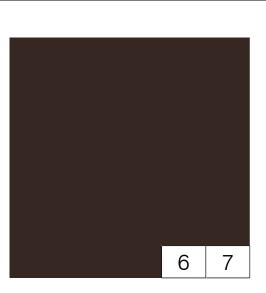




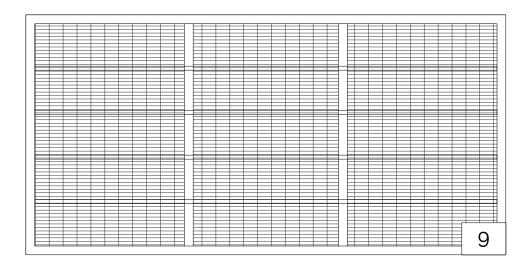



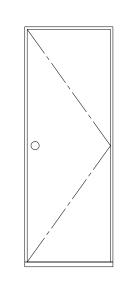

13

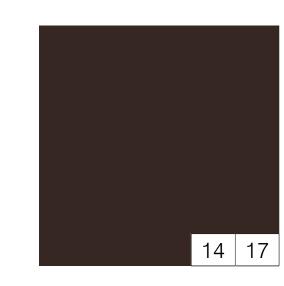







268 PARROTT STREET SAN LEANDRO, CA



Architecture Planning Interiors

444 Spear Street, Suite 105 San Francisco, CA 94105 www.hunthalejones.com

> t. 415-512-1300 f. 415-288-0288

MATERIAL BOARD

 SCALE:
 N.T.S.


 DATE:
 01.03.2019

 PROJECT:
 335006

## GRAPHIC SCALE ( IN FEET ) 1 inch = 20 feet

## TENTATIVE MAP 268 PARROTT STREET **TRACT** 8476 FOR CONDOMINIUM PURPOSES

CITY OF SAN LEANDRO ALAMEDA COUNTY STATE OF CALIFORNIA

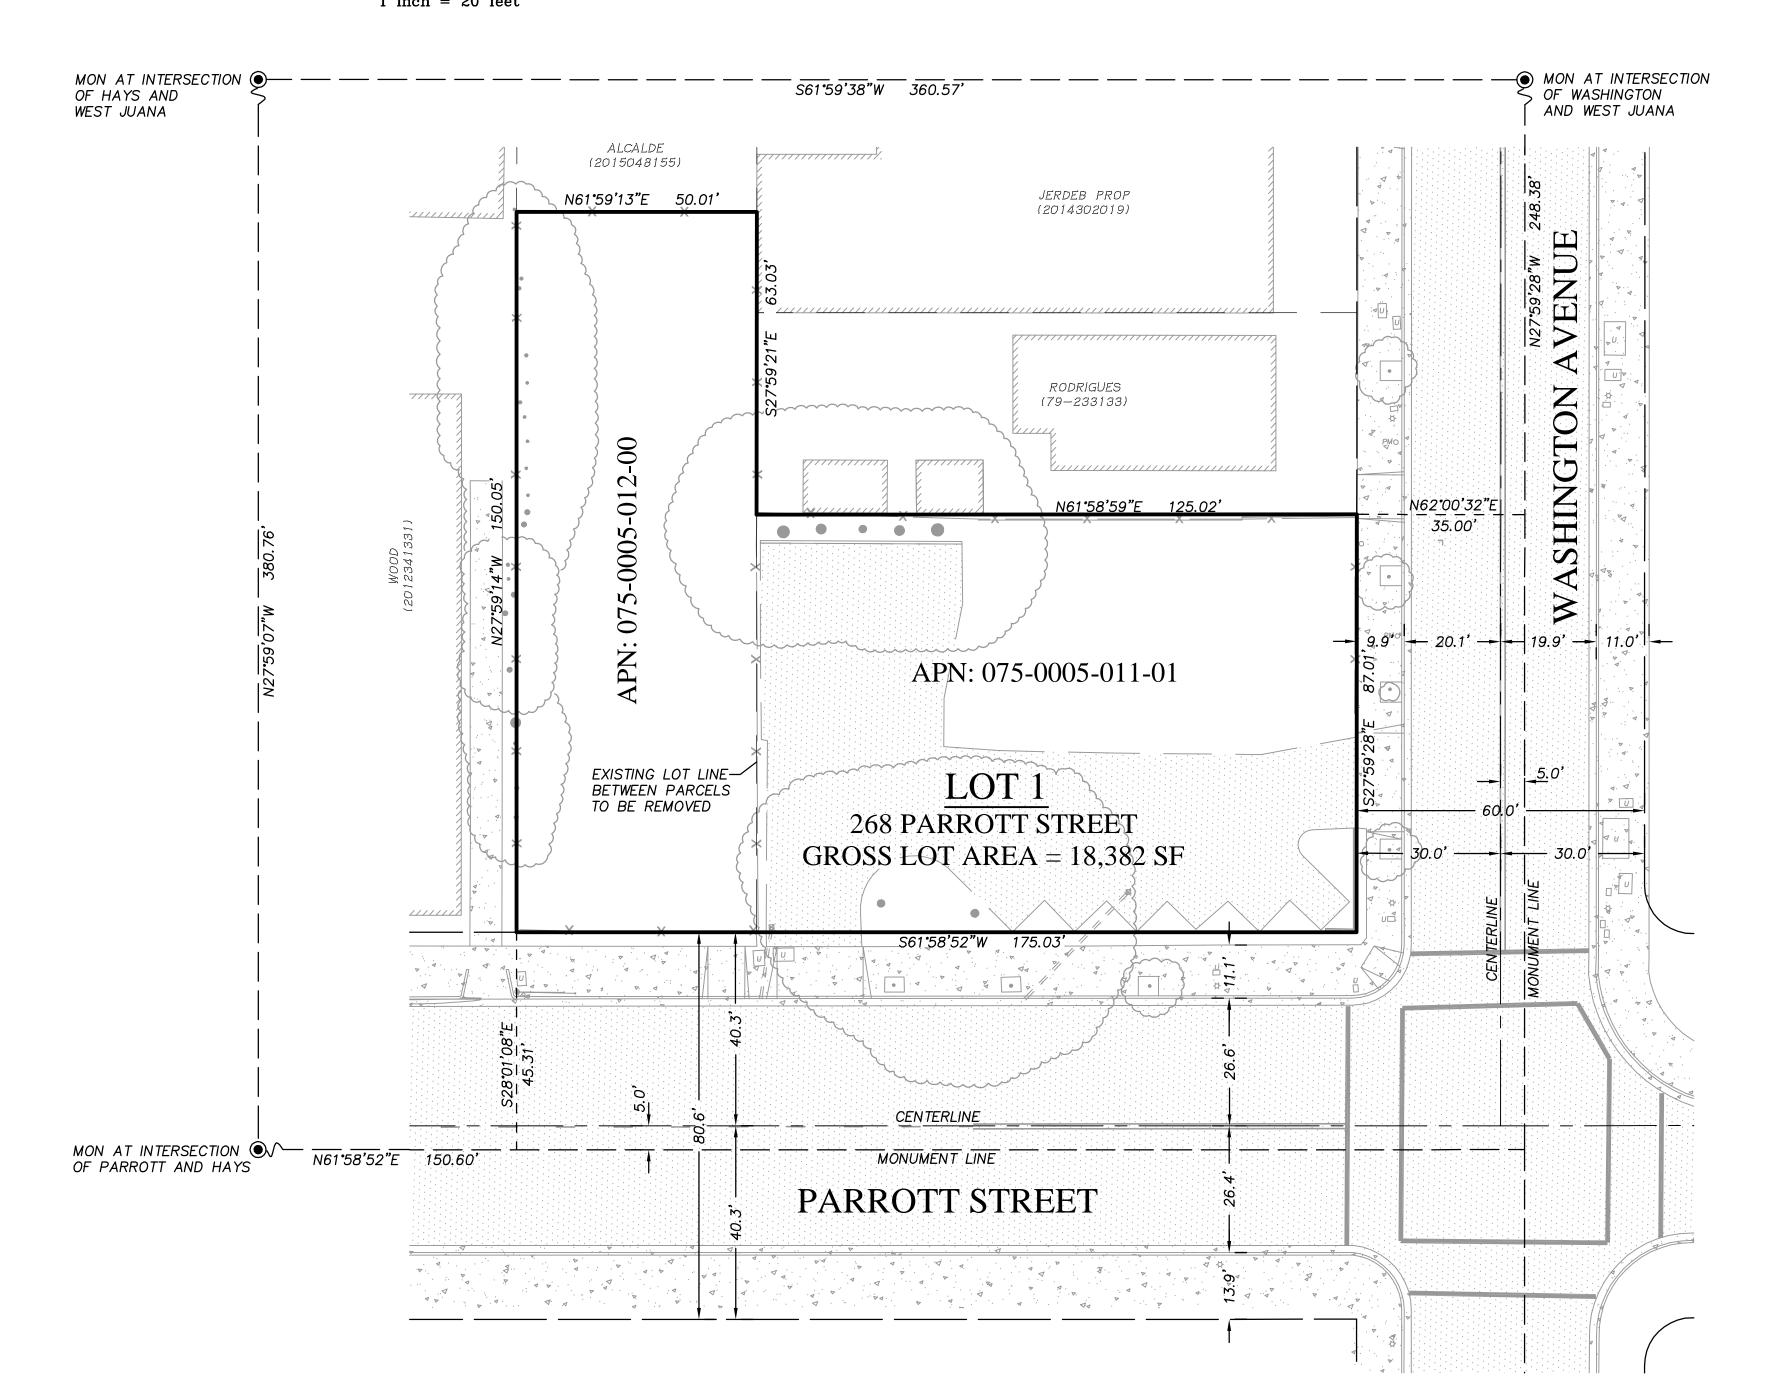



THE LOCATION OF ALL EXISTING UTILITIES SHOWN ON THE PLANS HAVE BEEN DETERMINED FROM THE BEST INFORMATION AVAILABLE. IT SHALL BE THE CONTRACTOR'S RESPONSIBILITY TO NOTIFY THE VARIOUS UTILITIES AND EXERCISE EXTREME CAUTION IN AREAS OF BURIED UTILITIES DURING CONSTRUCTION.

#### SHEET INDEX

SHEET No.	DESCRIPTION
SHEET NO.	DESCRIFTION
1	TENTATIVE MAP TITLE SHEET
2	TOPOGRAPHIC SURVEY & TREE PRESERVATION PLAN
3	DIMENSIONED SITE PLAN
4	PRELIMINARY GRADING, DRAINAGE & UTILITY PLAN
5	SECTIONS

#### **BENCHMARK**

CITY OF SAN LEANDRO BENCHMARK CINCH NAIL IN TOP OF CATCH BASIN INTERSECTION OF WEST JUANA AND WASHINGTON ELEVATION=51.79

#### BASIS OF BEARINGS

BEARINGS ARE BASED ON THE MONUMENT LINE OF PARROT STREET AS SHOWN ON THERECORD OF SURVEY RS 0662 (13 RS 39) TAKEN AS NORTH 61°59'42" EAST BETWEEN FOUND MONUMENTS

### **APPLICANT**

DAVID LANGON CONSTRUCTION 3189 DANVILLE BOULEVARD, SUITE 245 ALAMO, CA 94507 (925) 946-1850

#### **CIVIL ENGINEER**

APEX CIVIL ENGINEERING & LAND SURVEYING 817 ARNOLD DRIVE, SUITE 50 MARTINEZ, CA 94553 (925) 476-8499

#### **ARCHITECT**

HUNT HALE JONES ARCHITECTS 444 SPEAR STREET, SUITE 105 SAN FRANCISCO, CA 94105 (415) 568-3843

#### LANDSCAPE ARCHITECT

LEVESQUE PLANNING AND DESIGN 1414 BAY STREET, SUITE 100 ALAMEDA, CA 94501 (510) 521-6700

#### **GENERAL**

ASSESSORS PARCEL NO(s): 075-0005-012-00 & 075-0005-011-01 PROJECT ADDRESS: 268 PARROT STREET SAN LEANDRO, CA

TOTAL GROSS AREA: 18,382 SF EXISTING ZONING: DA-1 (DOWNTOWN AREA 1) DA-1 (DOWNTOWN AREA 1 PROPOSED ZONING: EXISTING GENERAL PLAN: DOWNTOWN MIXED USE

PARKING LOT/VACANT EXISTING USE: 26 CONDOMINIUMS UNITS + 1 COMMERCIAL UNIT PROPOSED USE:

PROPOSED DENSITY: 61.6 DU/AC LOT COVERAGE:

ZONE "X" (FIRM PANEL 0257G, DATED 08/03/09) FEMA FLOOD DESIGNATION: EXISTING TOPOGRAPHY DATE APRIL 2018

FIRE PROTECTION DISTRICT ALAMEDA COUNTY FIRE PROTECTION DIST.

#### **FACILITIES**

TELEPHONE:

MAXIMUM BUILDING HEIGHT

WATER: EAST BAY MUNICIPAL UTILITY DISTRICT (EBMUD) SEWER: CITY OF SAN LEANDRO STORM DRAIN: CITY OF SAN LEANDRO GAS & ELECTRIC:

PACIFIC GAS & ELECTRIC BROADBAND COMPARISON

#### PROJECT DATA FORM

PROJECT NAME/NUMBER	268 PARROTT STREET
PROJECT LOCATION	268 PARROTT STREET SAN LEANDRO, CA
NAME OF DEVELOPER	DAVID LANGON CONSTRUCTION
PROJECT TYPE AND DESCRIPTION	26 CONDOMINIUM UNITS + 1 COMMERCIAL UNIT
PROJECT WATERSHED	SAN LEANDRO CREEK WATERSHE
TOTAL PROJECT SITE AREA (ACRES)	0.42 ACRES (18,382 SF)
TOTAL NEW IMPERVIOUS SURFACE AREA (SQ. FT.)	12,197 SF
TOTAL REPLACED IMPERVIOUS SURFACE AREA	6,688 SF
TOTAL PRE-PROJECT IMPERVIOUS SURFACE AREA	5,657 SF
TOTAL POST-PROJECT IMPERVIOUS SURFACE AREA	18,885 SF
TOTAL NEW SITE COVERAGE	16,473 SF (89.6%)
RUNOFF REDUCTION MEASURES SELECTED	DISPERSE RUNOFF TO VEGETATED AREA(s)
	2. PERVIOUS PAVEMENT (PAVERS)
	3. CISTERNS OR RAIN BARRELS
	4. BIO-RETENTION FACILITY OR PLANTER
	5. MECHANICAL STORM FILTER SYSTEM (MSF)

THE SITE WILL BE COLLECTED AND CONVEYED TO THE PROPOSED MECHANICAL STORM FILTER TO TREAT THE RUNOFF FROM THE PROJECT BEFORE ENTERING THE PUBLIC STORM DRAIN SYSTEM.

LEGEND LOT BOUNDARY RIGHT-OF-WAY ADJACENT PROPERTY LINE NEW BUILDING EXISTING BUILDING EX. ASPHALT

**VICINITY MAP** 

NOT TO SCALE

EX. CONCRETE NEW ASPHALT

NEW CONCRETE

FINISHED GRADE SLOPE DIRECTION OF DRAINAGE FLOW

EX. TREE

STORM DRAIN LINE

#### **ABBREVIATIONS**

AB — AGGREGATE BASE AC – ACRE

 BOTTOM OF WALL CATCH BASIN CONC - CONCRETE

COSL - CITY OF SAN LEANDRO DET — DETAIL

DWELLING UNITS EXISTING

FINISH FLOOR FINISH GRADE FLOW LINE ELEVATION

GRATE ELEVATION GARAGE LIP ELEVATION

HIGH POINT LINEAR FEET

- NEW - PAD

PLANTER (FLOW THROUGH)

PROPERTY LINE PVC - POLYVINYL CHLORIDE

- RIGHT OF WAY

STORM DRAIN SDWK - SIDEWALK SQUARE FEET

STANDARD TOP OF CURB


TRENCH DRAIN TW - TOP OF WALL


TYP - TYPICAL

TENTATIVE MAP
TITLE SHEET
- FOR CONDOMINIUM PURPOSES
OTT STREET, SAN LEANDRO, CA

SHEET 1 OF 5 DATE

PROJECT #: 18025

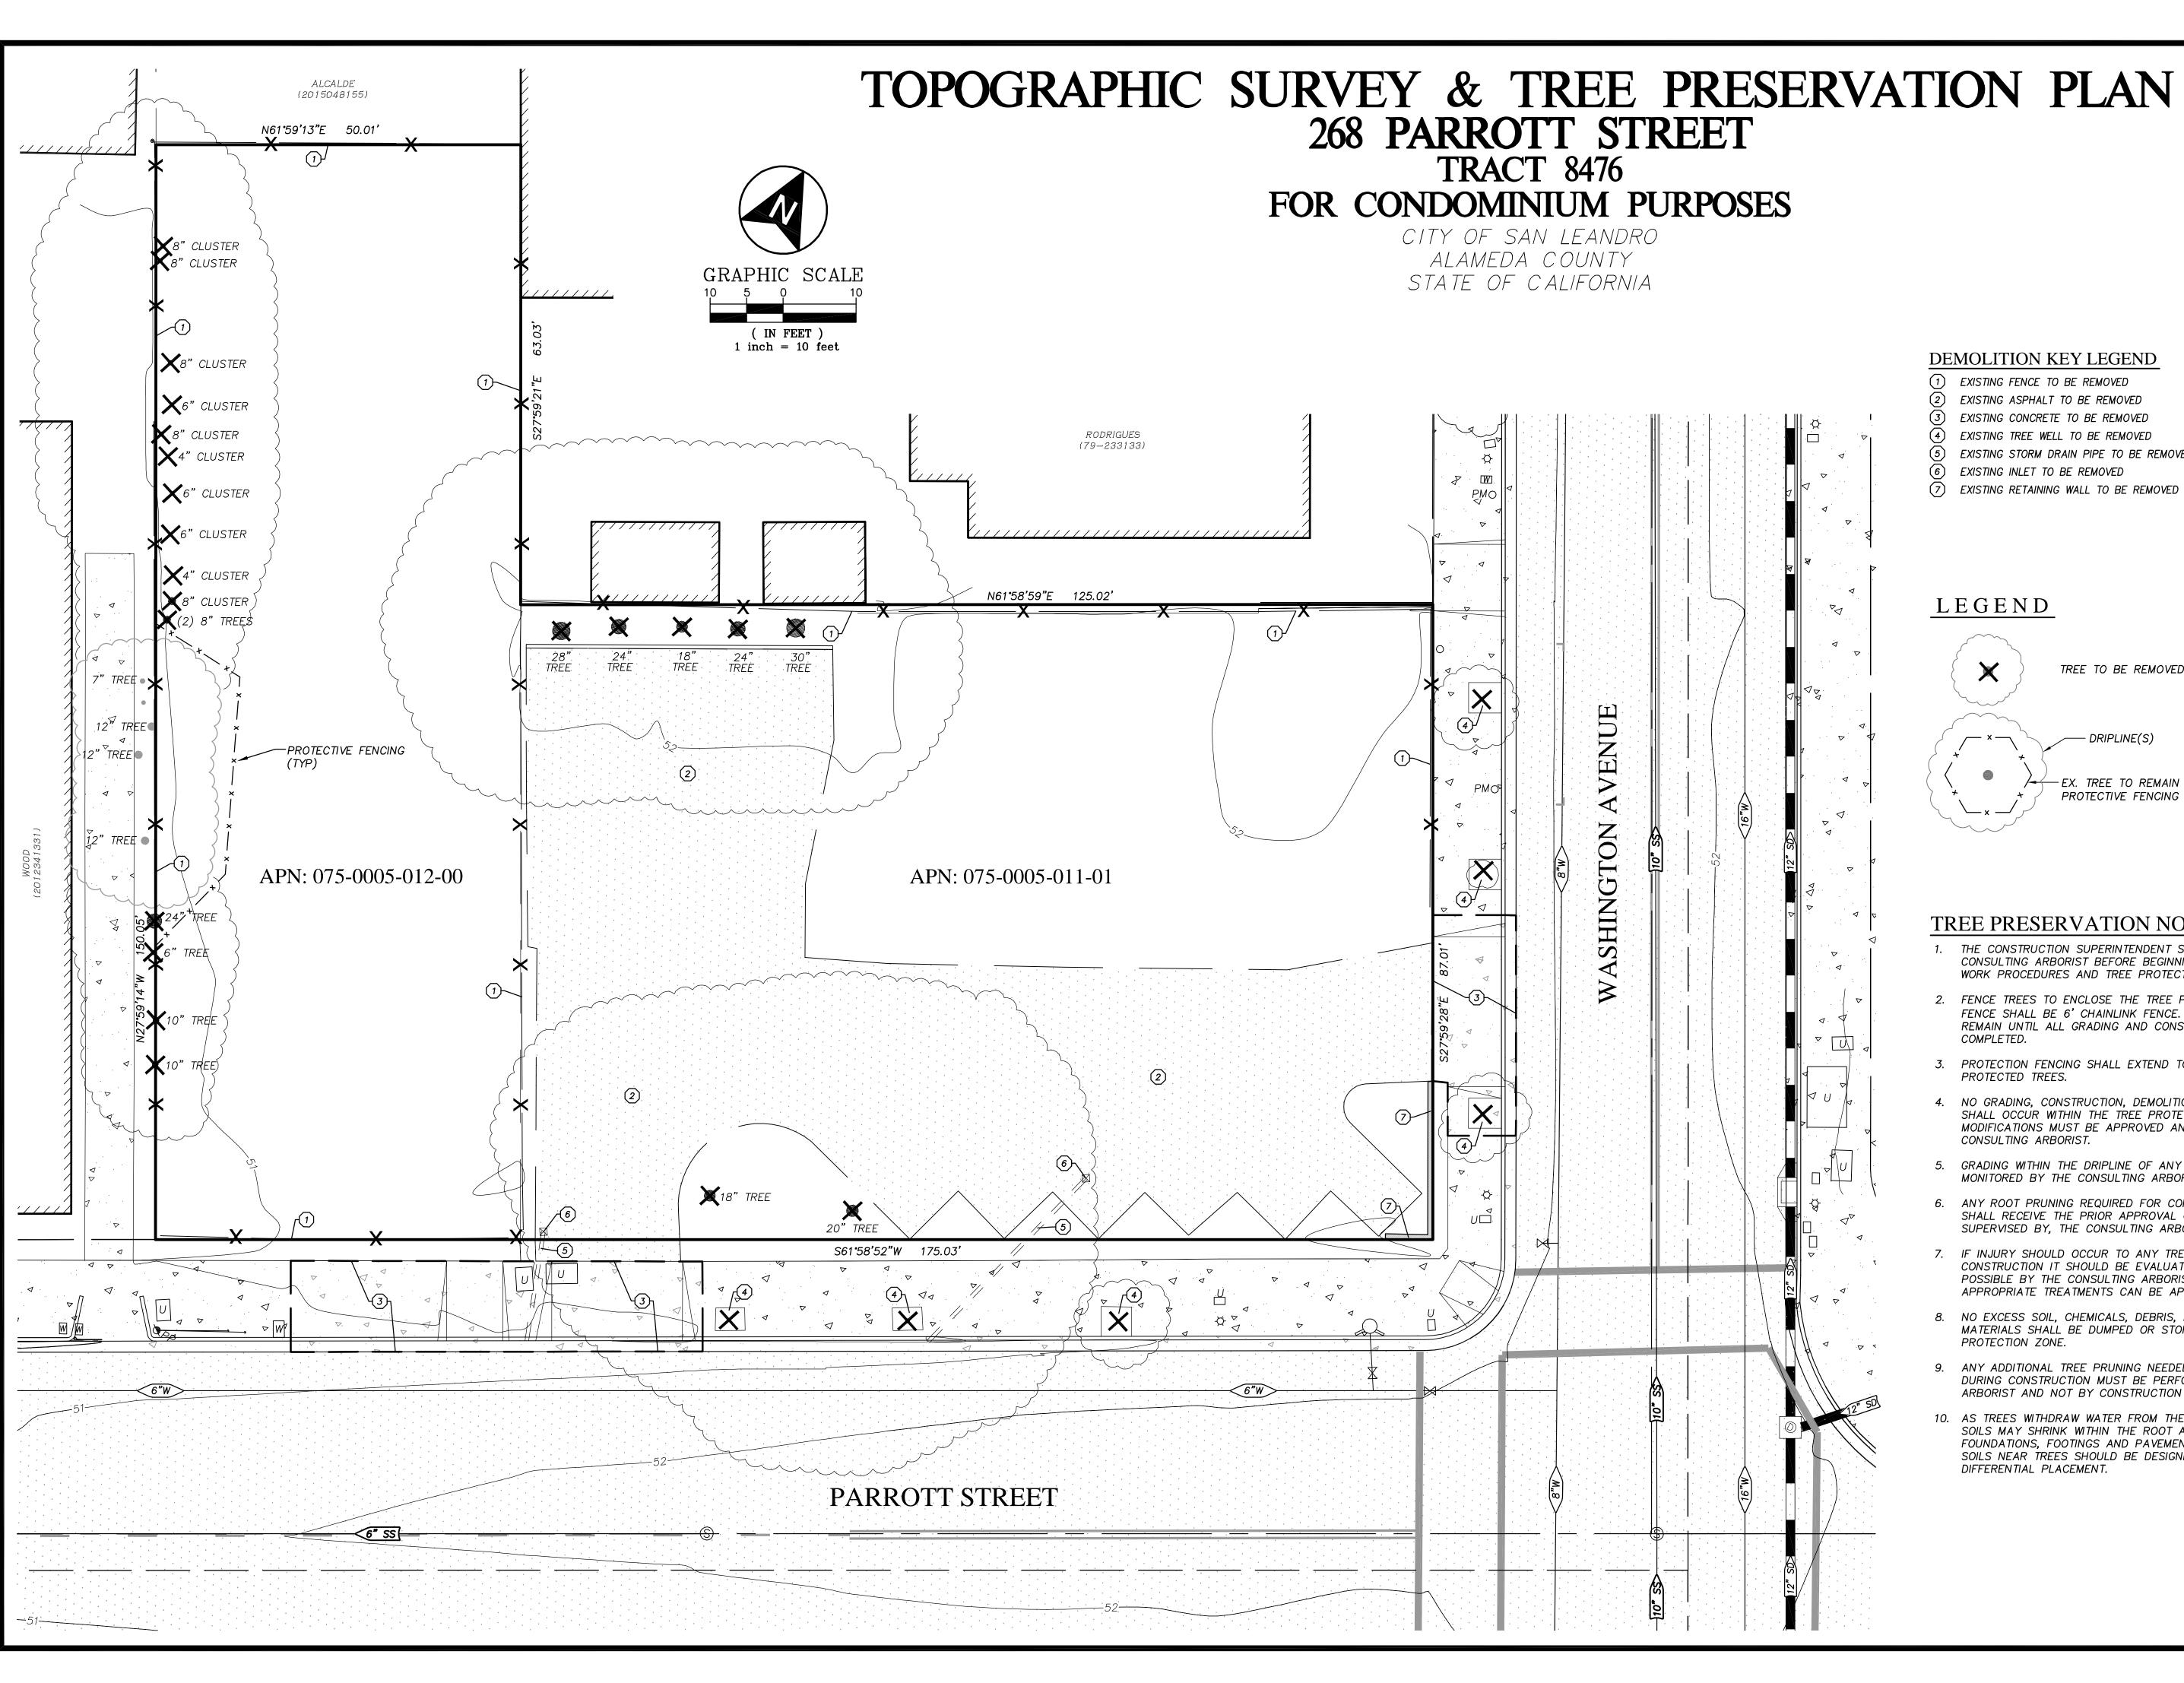

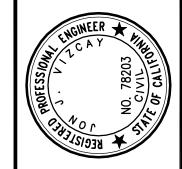

## TREE PRESERVATION NOTES

THE CONSTRUCTION SUPERINTENDENT SHALL MEET WITH THE CONSULTING ARBORIST BEFORE BEGINNING WORK TO DISCUSS WORK PROCEDURES AND TREE PROTECTION.

TREE TO BE REMOVED

- DRIPLINE(S)

EX. TREE TO REMAIN


PROTECTIVE FENCING (6' CHAINLINK FENCE)


- 2. FENCE TREES TO ENCLOSE THE TREE PROTECTION ZONE. FENCE SHALL BE 6' CHAINLINK FENCE. FENCES ARE TO REMAIN UNTIL ALL GRADING AND CONSTRUCTION IS
- PROTECTION FENCING SHALL EXTEND TO THE DRIPLINE OF THE
- 4. NO GRADING, CONSTRUCTION, DEMOLITION OR OTHER WORK SHALL OCCUR WITHIN THE TREE PROTECTION ZONE. ANY MODIFICATIONS MUST BE APPROVED AND MONITORED BY THE CONSULTING ARBORIST.
- 5. GRADING WITHIN THE DRIPLINE OF ANY TREE SHALL BE MONITORED BY THE CONSULTING ARBORIST.
- 6. ANY ROOT PRUNING REQUIRED FOR CONSTRUCTION PURPOSES SHALL RECEIVE THE PRIOR APPROVAL OF, AND BE SUPERVISED BY, THE CONSULTING ARBORIST.
- 7. IF INJURY SHOULD OCCUR TO ANY TREE DURING CONSTRUCTION IT SHOULD BE EVALUATED AS SOON AS POSSIBLE BY THE CONSULTING ARBORIST SO THAT APPROPRIATE TREATMENTS CAN BE APPLIED.
- 8. NO EXCESS SOIL, CHEMICALS, DEBRIS, EQUIPMENT OR OTHER MATERIALS SHALL BE DUMPED OR STORED WITHIN THE TREE PROTECTION ZONE.
- ANY ADDITIONAL TREE PRUNING NEEDED FOR CLEARANCE DURING CONSTRUCTION MUST BE PERFORMED BY A CERTIFIED ARBORIST AND NOT BY CONSTRUCTION PERSONNEL.
- 10. AS TREES WITHDRAW WATER FROM THE SOIL, EXPANSIVE SOILS MAY SHRINK WITHIN THE ROOT AREA. THEREFORE, FOUNDATIONS, FOOTINGS AND PAVEMENTS ON EXPANSIVE SOILS NEAR TREES SHOULD BE DESIGNED TO WITHSTAND DIFFERENTIAL PLACEMENT.

SHEET

DATE

PROJECT #: 18025

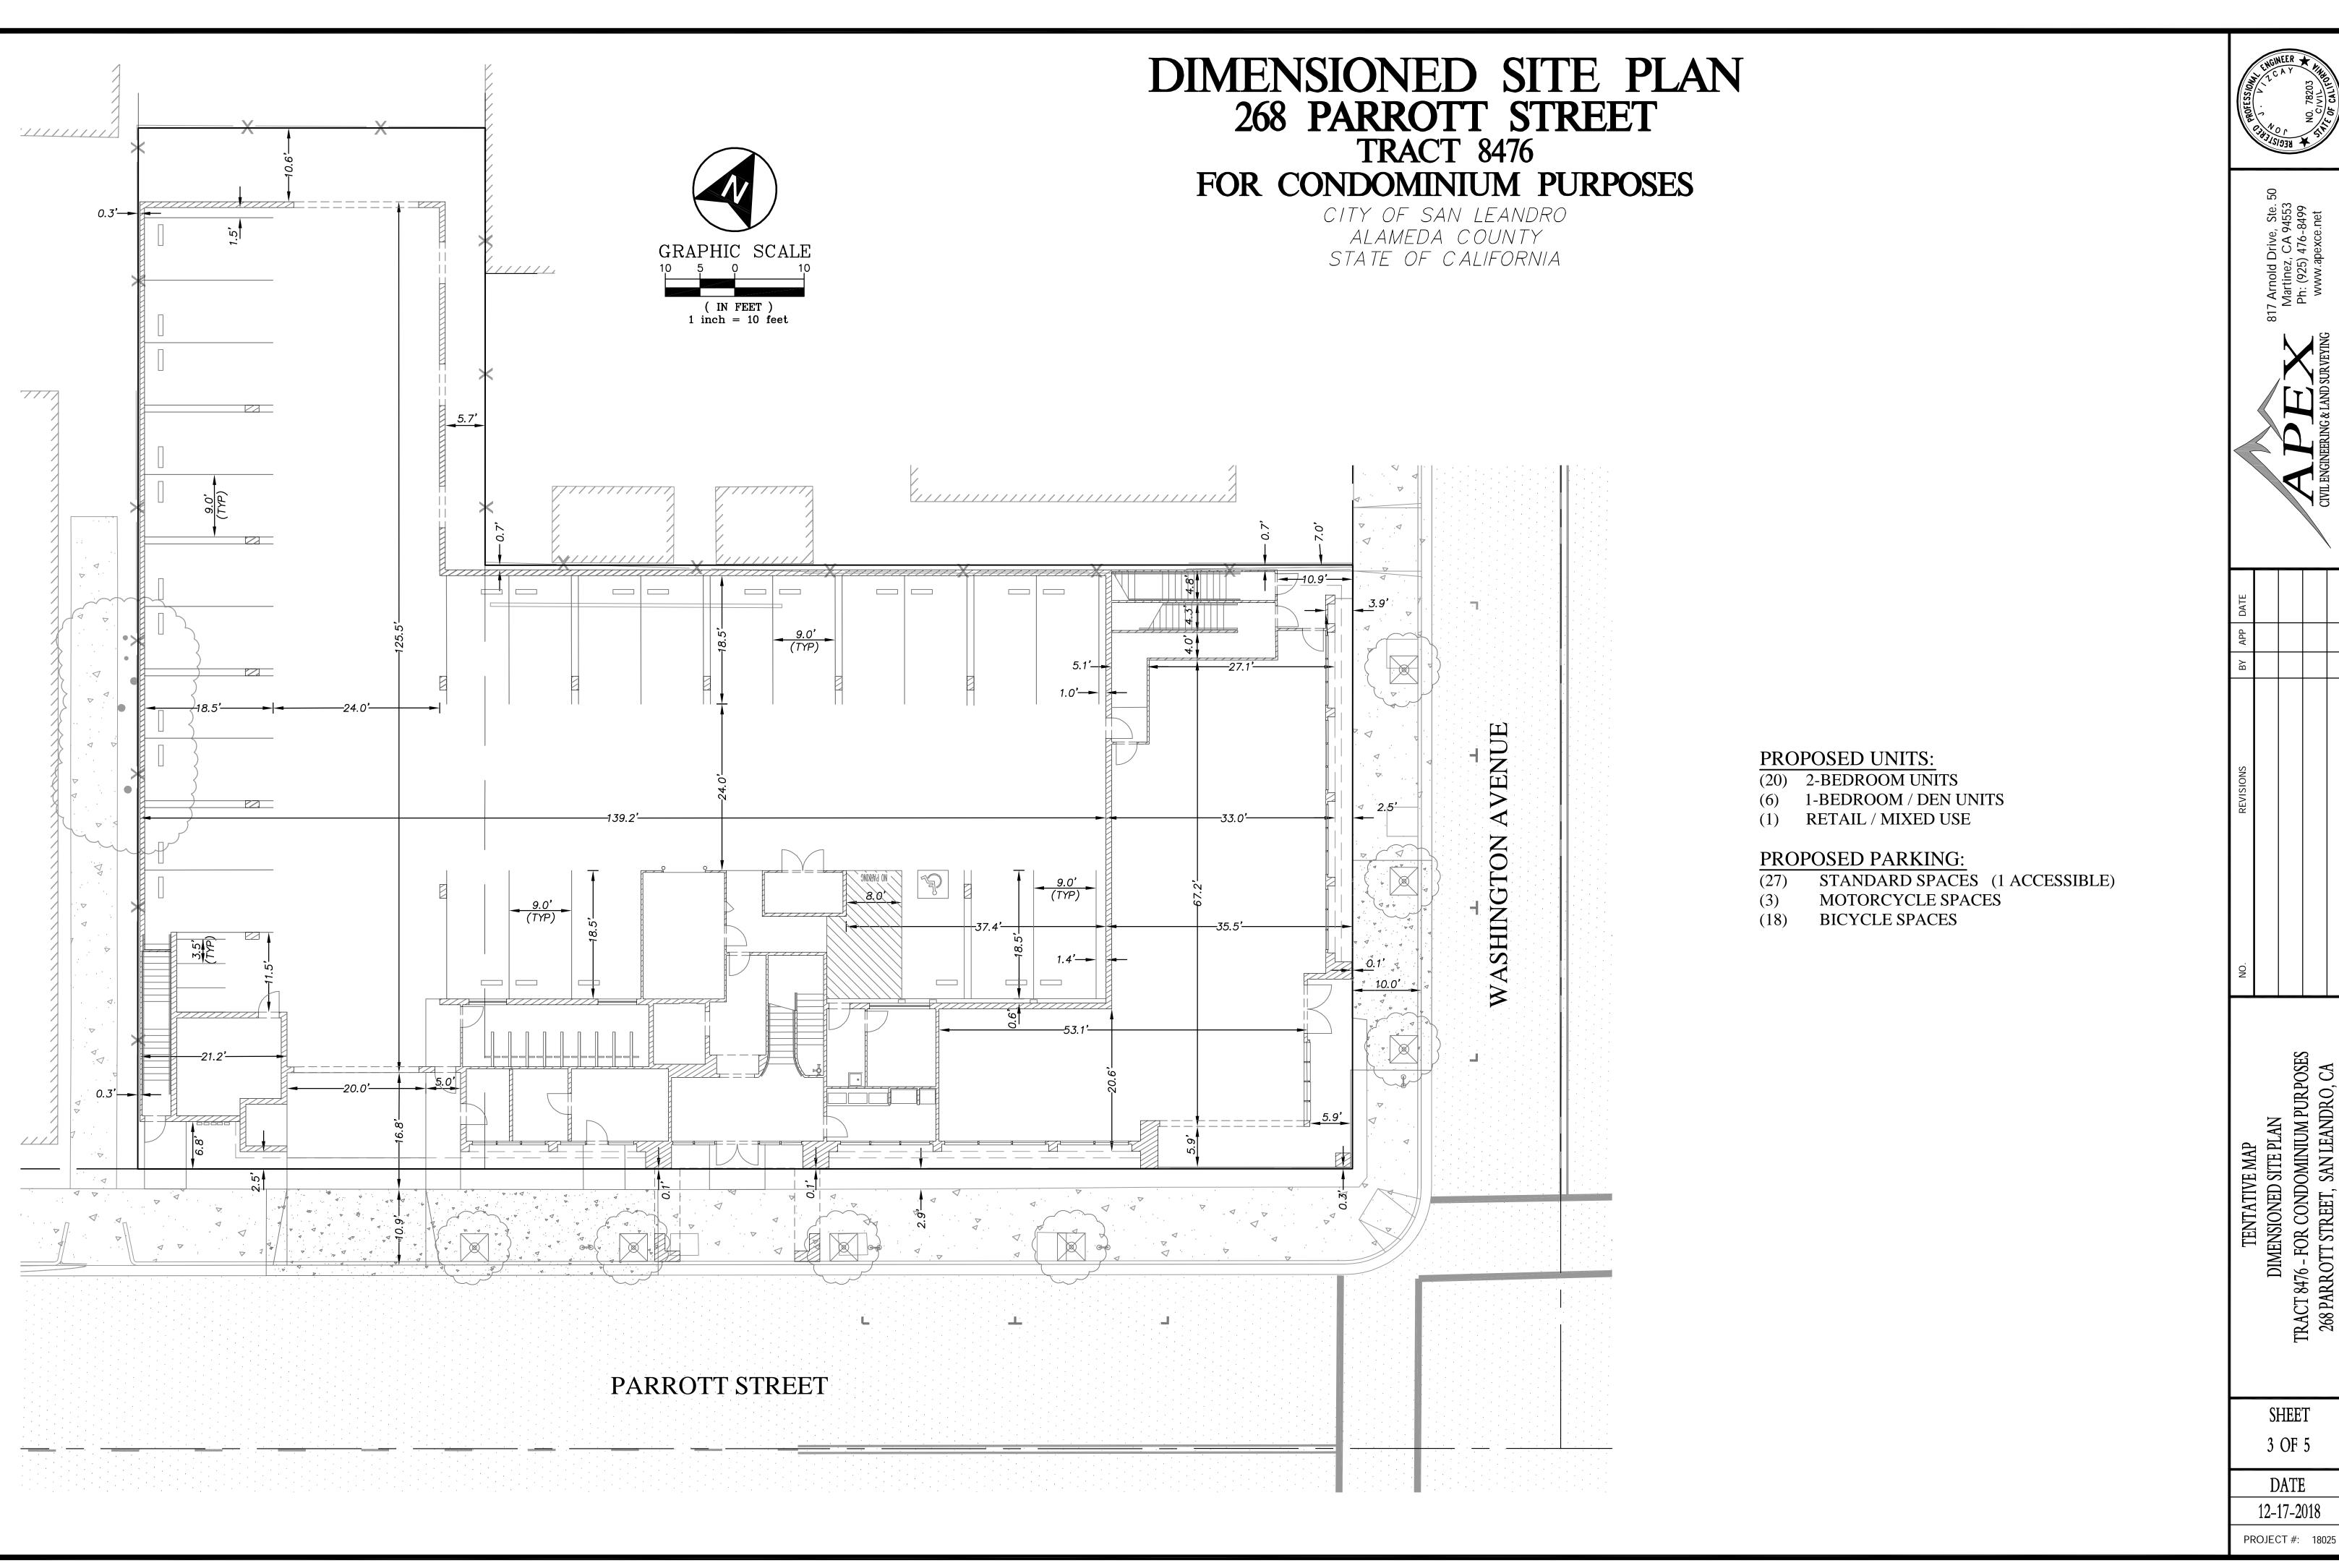

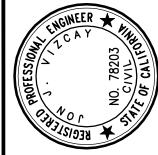



SHEET 3 OF 5

DATE 12-17-2018