

"CONDITIONAL USE PERMIT" FOR AHERN RENTALS

2062 - 2091 WEST AVENUE 140TH, SAN LEANDRO, CA

PROJECT TEAM

OWNER

TERRENO REALTY CORPORATION 101 MONTGOMERY STREET, SUITE 200 SAN FRANCISCO, CA 94104

415.655.4442

TENANT

AHERN RENTALS, INC. 8305 EASTGATE ROAD HENDERSON, NV 89015 702.362.0623

ARCHITECT

CHOI+ROBLES ARCHITECTURE 2251 HARBOR BAY PKWY ALAMEDA, CA 510.523.9123

LANDSCAPE ARCHITECT

RANDY DE VALE PO BOX 2641 CASTRO VALLEY, CA 94546 510.581.4151

NOTES

GENERAL NOTES:

THE PURPOSE OF THESE DRAWINGS IS TO PROVIDE INFORMATION FOR A "CONDITIONAL USE PERMIT" APPLICATION AFTER APPROVAL. A COMPLETE SET OF DWGS. WILL BE PREPARED AND SUBMITTED FOR A BUILDING PERMIT APPLICATION,

PLANNING

BASIC BUILDING INFORMATION. . . . THIS SHEET CONCEPTUAL LANDSCAPE......SEE SHEET L1.0

STORAGE SCREENING. NOT APPLICABLE. NO EXTERIOR STORAGE

SITE IMPROVEMENTS..... FUELING STATION, BAY WASH AND 10' LANDSCAPE SETBACK AND FENCE. SHEET A1

BUSINESS STATEMENT. THIS SHEET

BUILDING SIGNAGE, TO BE PROVIDED/PROCESSED DURING BUILDING PERMIT APPLICATION

REFUSE AREA NON-VISIBLE FROM STREET VIEW.

2062 BUILDING - LOCATED INSIDE BUILDING BY ROLL-UP DOOR. SEE SITE PLAN A1.1 2091 BUILDING - LOCATED INSIDE FIRST BAY OF STORAGE SHED. SEE SITE PLAN A1. NOTE: BINS ARE EASILY ACCESSIBLE TO COLLECTION VEHICLES. STORAGE AREA

ADEQUATE TO ACCOMODATE VARIOUS BINS.

FIRE

NOTE: COMPLETE SET OF DRAWINGS. INCLUDING MECHANCAL. ELECTRICAL AND PLUMBING TO BE SUBMITTED DURING

BUILDING PERMIT APPLICATION.

FUELING STATION..... SEE SHEET A1.1 SITE PLAN FOR LOCATION SEE SHEET A3.1 FOR PLAN. ELEVATION AND DOUBLE WALL TANK INFORMATION

SEE SHEET A3.2 FOR DISPENSING EQUIPMENT INFORMATION.

AND BUILDINGS.

WELDING..... NO WELDING AT THIS FACILITY

SPILL CONTROL FUELING STATION IS 50' AWAY FROM (E) SHED BUILDING AND 150' + FROM

THE CLOSEST DOOR TO BUILDING 2091

NOTE: A CONTINUOUS 6" HIGH CONCRETE CURB WILL BE PLACED AROUND

FUELING STATION (INCLUDING SPILL CONTROL GEAR).

PLANNED HAZ-MAT AT FACILITY

MATERIAL	QUANTITY	CONTAINER
OIL FOR MOTOR, TRANSMISSION AND GEAR	1,000 GAL	. U.L. VAULTED DOUBLE WALL CONTAINER
SOLVENTS, DEGREASERS	25 GAL. (SPRAY)	. AEROSOL CONTAINERS STORED IN FLAMMABLE LIQUIDS CONTAINER
LEAD ACID BATTERIES	20 TO 30 UNITS	WET SEALED BATTERIES
DIESEL FUEL	1,000 GAL	• U.L. LISTED DOUBLE WALL CONTAINER - AT EXTERIOR
UNLEADED GAŞ	. 500 GAL	. U.L. LISTED DOUBLE WALL CONTAINER - AT EXTERIOR
ACETYLENE GAS (WELDING)	1 TO 4 BOTTLES	. 400 TO 600 CU. FT.
OXYGEN (WELDING)	1 TO 4 BOTTLES	. 400 TO 600 CU. FT.
PROPANE (FUEL EQUIPMENT)		
ANTI-FREEZE 50/50		
WASTE OIL	250 GAL	. REMOVED BY LISCENSED CONTRACTOR

NOTE: ADDITIONAL INFORMATION REQUIRED TO BE PROVIDED DURING BUILDING PERMIT APPLICATION

BUSINESS STATEMENT



December 12, 2016

Anjana Mepani

City of San Leandro

Planner II, Community Development Department

835 East 14th Street San Leandro, CA 94577

Dear Ms. Mepani:

Ahern Rentals, Inc. ("Ahern") is a construction equipment dealer and rental company. Ahern was formed in 1953, has 87 locations in North America and is the largest privately owned equipment rental company in the world. Ahern both sells and rents heavy construction equipment and aerial lift equipment. This location will provide services for both selling and renting such equipment. Our operations are very similar to Sunbelt Rentals, which has a location in San Leandro, and others such as United Rentals. We are a community oriented and responsible company that contributes both economically and philanthropically to the communities in which it is located.

Our normal business hours are anticipated to be from 3:00 AM to 5:00 PM Monday through Friday. We will have truck traffic in the early morning hours, from 3:00 AM to 5:00 AM with our trucks delivering to construction and industrial sites and returning on site in the midafternoon. We have moderate traffic during the day. We deliver a majority of the equipment to our customers and there is very little customer traffic at our location. We typically have less truck traffic than a typical distribution warehouse. We plan on having 4 low boy trucks and 2 eighteen wheelers by the end of summer operating out of the facility. We do maintain our equipment with certified mechanics on site.

We plan to have a wash bay on site. However, it is a totally self-contained, closed loop system. We recycle and reuse 100% of the water used in the process. We are enclosing a description and design of the recycling system. We will be employing approximately 30 fulltime persons on site, including drivers and mechanics. Our wage rates range from the \$15 to \$39 per hour rate.

Should you have any questions or require further information, please do not hesitate to contact me. Thank you for your anticipated cooperation.

M. Sami Bakdash, Esq. VP of Legal and General Counsel Ahern Rentals, Inc.

ESTIMATED TRIPS FOR AHERN RENTALS FACILITY (2091 BUILDING). PER BUSINESS STATEMENT ABOVE.

6 TRIPS IN THE AM 6 TRIPS IN THE PM

HOURS OF OPERATION: 3 A.M. TO 5 P.M.

DRAWING INDEX

ARCHITECTURAL A0.0 COVER SHEET A1.1 2062 AND 2091 BUILDINGS - SITE PLAN A1.2 PROPOSED LANDSCAPE AREAS A1.3 ENLARGED CUL-DE-SAC ENTRANCE PLAN A2.1 (E) 2091 BUILDING FLOOR PLAN AND ELEVATION A2.2 (E) STORAGE SHED ELEVATIONS FUELING STATION PLAN, FUEL TANKS PLAN, ELEVATION AND CUT SHEETS A3.2 FUEL DISPENSING EQUIPMENT INFORMATION WATER RECYCLING SYSTEM PLAN. ELEVATION AND DESCRIPTION. WASH BAY PLAN CONCEPTUAL LANDSCAPE - PLANTING PLAN CIVIL SURVEY FOR REFERENCE ONLY

PROJECT DATA

OCCUPANCY.

```
PROJECT ADDRESS:
                                      2062 AND 2091 WEST AVENUE 140TH
                                      SAN LEANDRO, CA
PARCEL NUMBERS
                                      .APN: 77B-853-38-1
                                      IG - INDUSTRIAL GENERAL DISTRICT
ZONING
SITE AREA:
                                      ..355.885 S.F. (8.17 AC)
TYPE OF BUILDING CONSTRUCTION: .......TYPE III-B, SPRINKLERED NOTE: SHED TYPE III-B, NON-SPRINKLERED)
BUILDING AREA:
      DESCRIPTION
                                      WAREHOUSE
                                                       OFFICE
                                                                        TOTAL
      BUILDING 2062
                                                        ...2,100 S.F.
                                                                        ..68,100 S.F.
                                                                                        ...VACANT
                                      .66,000 S.F.,
      BUILDING 2091
                                                                                         ..AHERN RENTALS
                                      ..29,736 S.F...
                                                       ....2,097 S.F...
                                                                       ...31,833 S.F.
                                      . 24,900 S.F.
                                                                       ...24,900 S.F.
      STORAGE SHED (2091).
                                                                                         ...AHERN RENTALS
                                                       4.197 S.F.
                                     120.636 S.F.
                                                                      124.833 S.F.
FLOOR AREA RATIO (FAR)
                                      .124,833 S.F. (BUILDINGS) / 355,885 S.F. (SITE) = 0.35 F.A.R.
BUILDING HEIGHT
      BUILDING 2062
                                      .. 22'-0" - PARAPET TO 30'-0" HIGH ROOF
                                      .. 25'-0" - PARAPET
      BUILDING 2091
      STORAGE SHED
                                      .22'-0" - HIGH POINT
```

PARKING REQUIRED / PROVIDED

```
BUILDING 2062 (1 STORY - SPRINKLERED) - V A C A N T
     OFFICE (B)
                               ...2,100 \text{ S.F. +/-} (2100 / 300 = 7 PARKING SPACES REQUIRED)
     WAREHOUSE (S1)...
                               66.000 S.F. +/- (66.000 / 1500 = 44 PARKING SPACES REQUIRED)
     TOTAL:
                                                       51 PARKING SPACES REQUIRED / PROVIDED
                                68.100 S.F.
PROPOSED USES:
                                .WAREHOUSE/OFFICE
SITE PARKING:
                                 43 STANDARD
                                 6 CLEAN AIR / CAR POOL / ELECTRIC
                                 2 ACCESSIBLE (1 VAN).
                                 51 TOTAL PARKING
BUILDING 2091 (1 STORY - SPRINKLERED) - AHERN RENTALS
                                           OFFICE (B)...
                                                 (2097 / 300 = 7 PARKING SPACES REQUIRED)
     WAREHOUSE (29,736 S.F. - S1)
                  WAREHOUSE
                                 27,736 S.F. (27,735 / 1500 = (18.5) 19 PARKING SPACES REQUIRED)
                 MAINTENANCE
                                 2.000 S.F.
                                                 (2,000 / 400 = 5 PARKING SPACES REQUIRED)
     TOTAL:
                                31,833 S.F +/-
                                                          31 PARKING SPACES REQUIRED / PROVIDED
PROPOSED USES:
                                OFFICE/WAREHOUSE
                                                                              25 STANDARD
SITE PARKING:
                                 4 CLEAN AIR / CAR POOL / ELECTRIC
                                 2 ACCESSIBLE (1 VAN).
                                 31 TOTAL PARKING
STORAGE SHED.
                . 24,900 S.F. +/-
                             (EXISTING ACCESSORY BUILDING - NON SPRINKLERED)
```

S-2 EQUIPMENT STORAGE

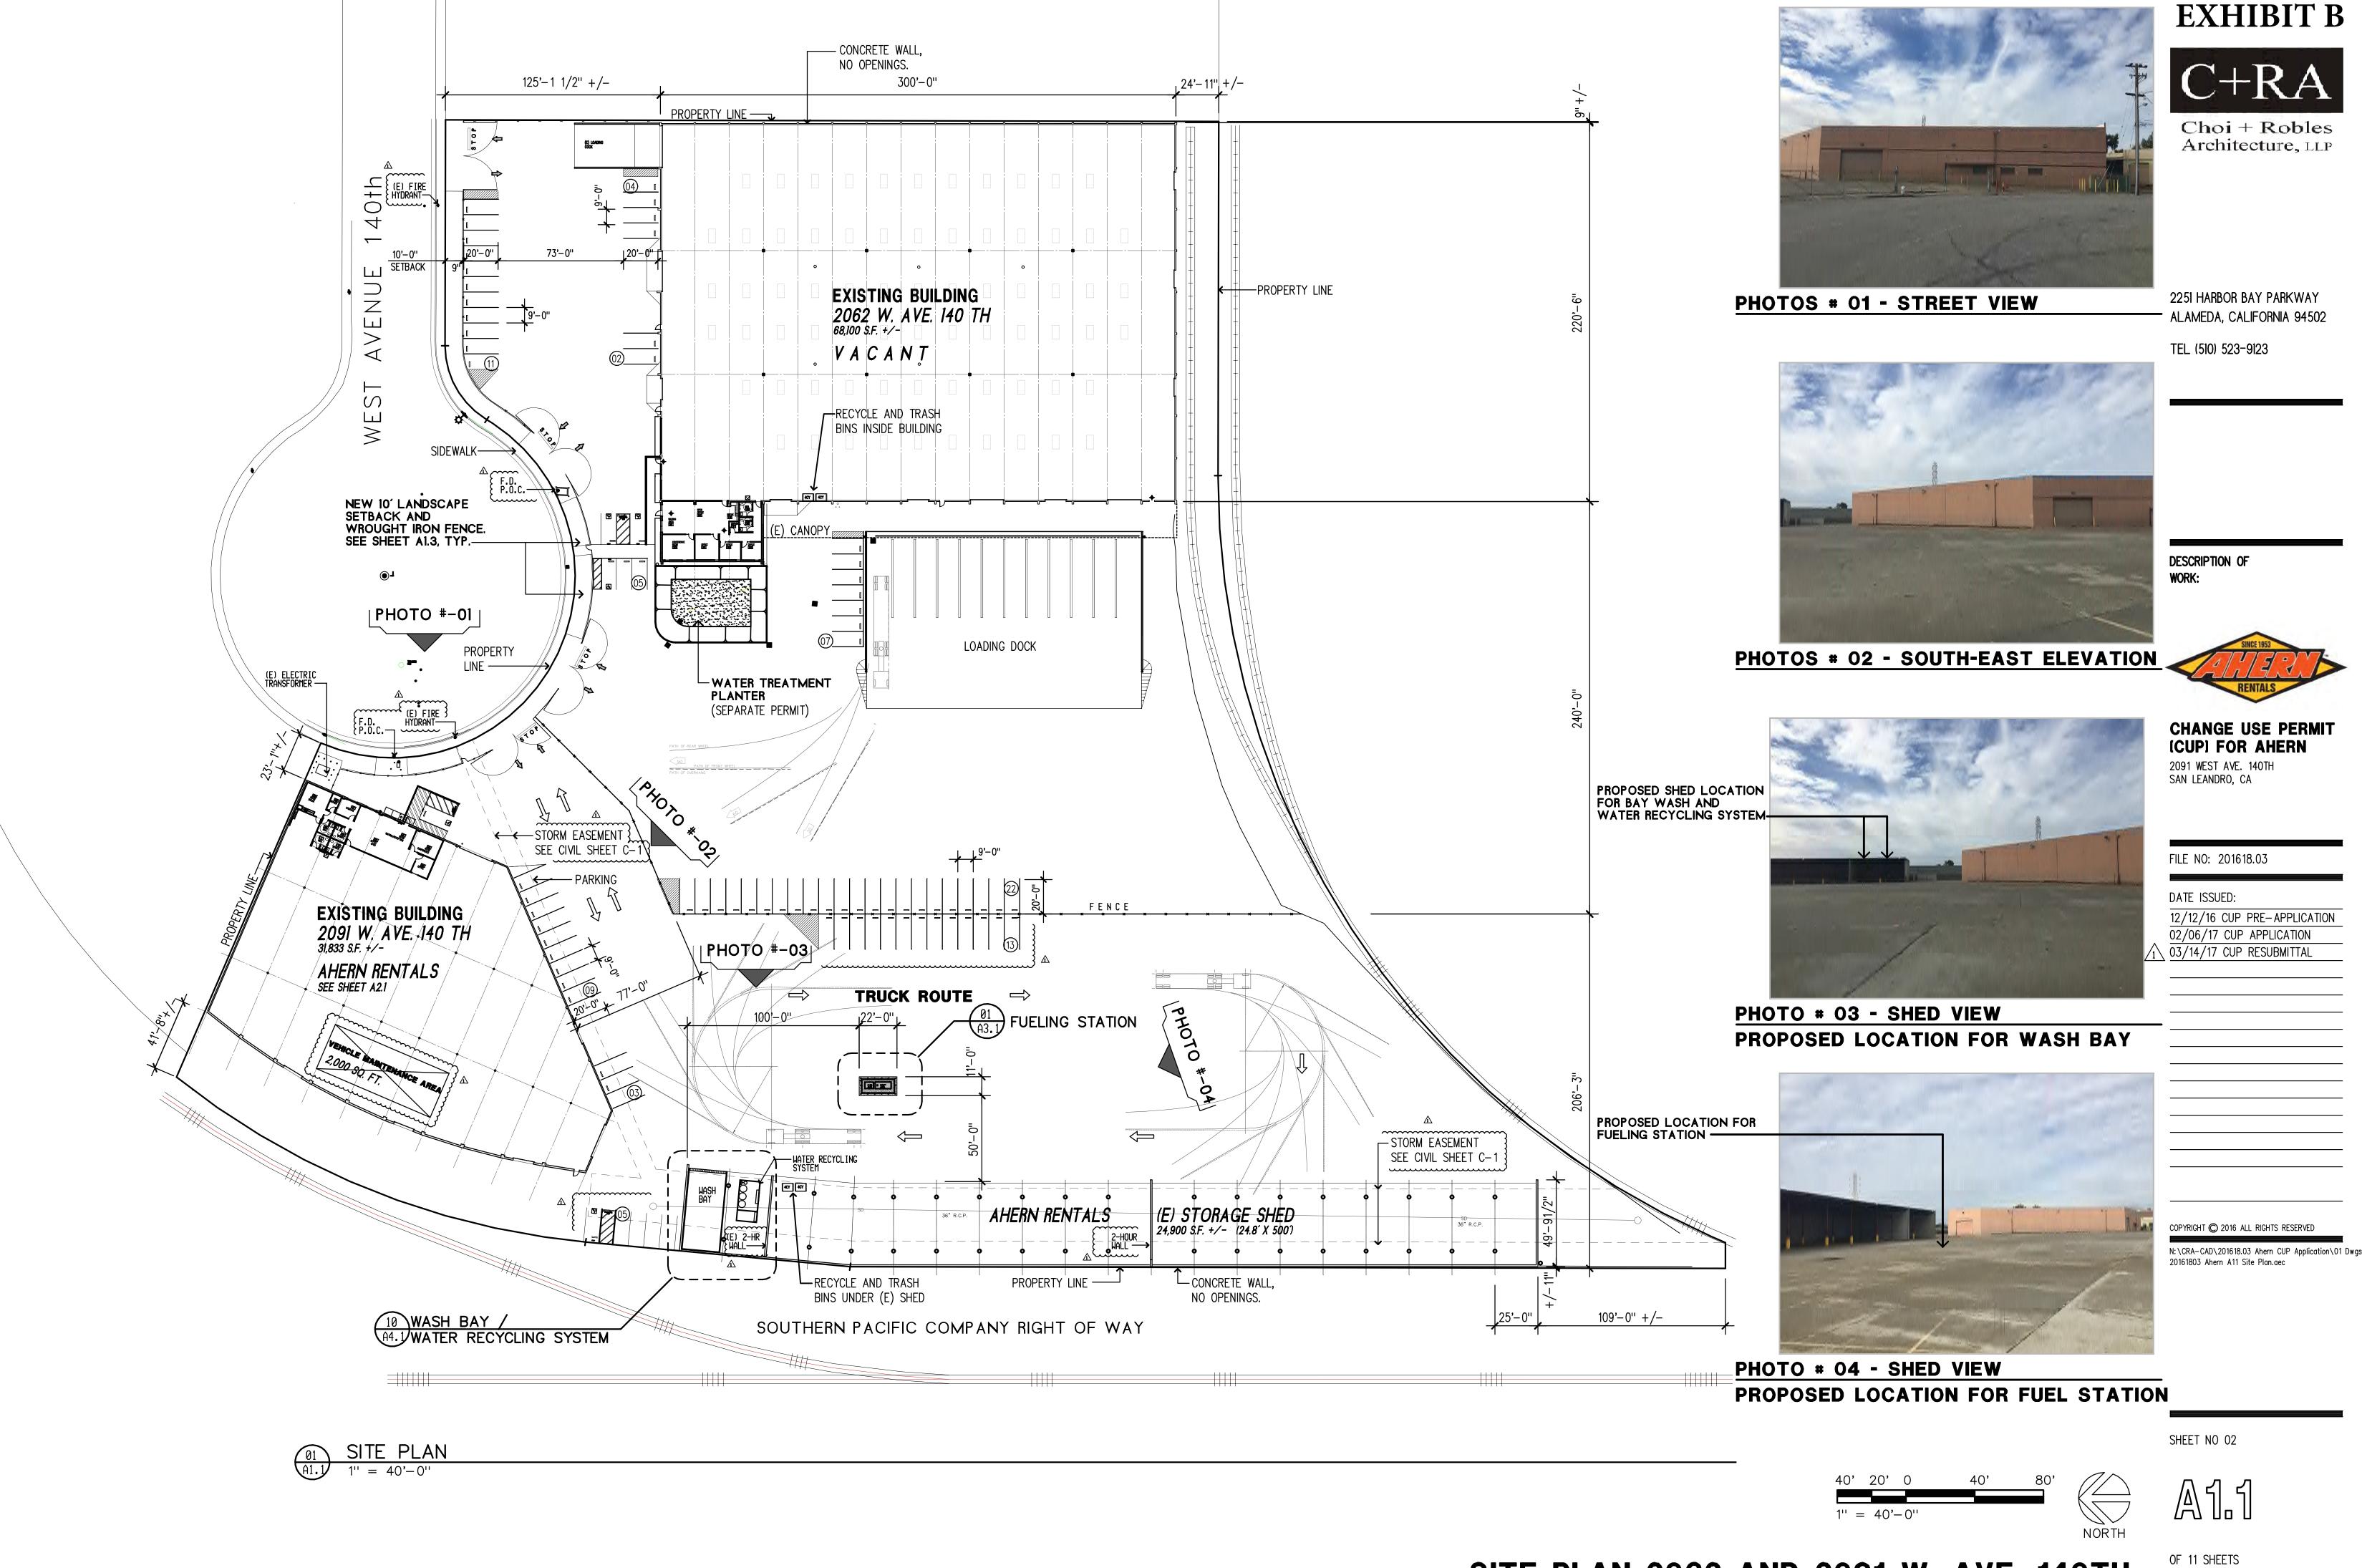


EXHIBIT C

- C+RA

Choi + Robles Architecture, LLP

2251 HARBOR BAY PARKWAY ALAMEDA, CALIFORNIA 94502

TEL (510) 523-9123

DESCRIPTION OF WORK:



CHANGE USE PERMIT (CUP) FOR AHERN 2091 WEST AVE. 140TH SAN LEANDRO, CA

FILE NO: 201618.03

DATE ISSUED: $\frac{12/12/16 \text{ CUP PRE-APPLICATION}}{02/06/17 \text{ CUP APPLICATION}}$ $\frac{03/14/17 \text{ CUP RESUBMITTAL}}{03/14/17 \text{ CUP RESUBMITTAL}}$

COPYRIGHT © 2016 ALL RIGHTS RESERVED

N:\CRA-CAD\201618.03 Ahern CUP Application\01 Dwgs 20161803 Ahern A12 Site Plan Landscape Areas.aec

SHEET NO 03

A1.2

OF 11 SHEETS

SHEET NOTES

- 01 (E) CONCRETE SIDEWALK (REPAIRED UNDER SEPARATE PERMIT NUMBER).
- REMOVE (E) CONCRETE PAVING AND PROVIDE 10' LANDSCAPE SETBACK SEE SHEET A1.2 FOR LANDSCAPE AREAS AND L1.0 FOR PLANTING PLAN
- NEW 8' HIGH WROUGHT IRON FENCE AND GATES WITH VANDAL RESISTANT TOP. SEE DETAIL BELOW.
- 04 RETURN WROUGHT IRON FENCE TO MEET BUILDING.
- 05 NEW 30' WROUGHT IRON GATE TO MATCH FENCE
- 06 NEW 40' WROUGHT IRON GATE TO MATCH FENCE
- NEW 3'-0" MAN GATE WITH LEVER LOCK AND PROTECTIVE SCREEN. HARDWARE TO BE FREE-EXIT. PROVIDE KNOX BOX.
- 08 WATER TREATMENT PLANTER. WORK UNDER SEPARATE PERMIT.






Choi + Robles Architecture, LLP

2251 HARBOR BAY PARKWAY ALAMEDA, CALIFORNIA 94502

TEL (510) 523-9123

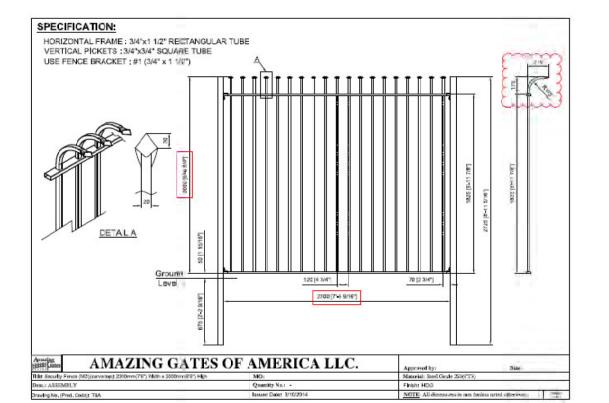

PROPOSED 8' WROUGHT IRON FENCE

DESCRIPTION OF WORK:



CHANGE USE PERMIT (CUP) FOR AHERN 2091 WEST AVE. 140TH SAN LEANDRO, CA

FILE NO: 201618.03

DATE ISSUED:


12/12/16 CUP PRE-APPLICATION
02/06/17 CUP APPLICATION

 $1 \sqrt{\frac{03}{14}/17}$ CUP RESUBMITTAL

COPYRIGHT © 2016 ALL RIGHTS RESERVED

20161803 Ahern A13 Enlarged Entrance Plan.aec

SHEET NO 04

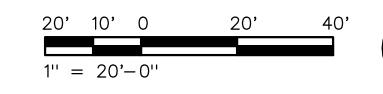



OF 11 SHEETS

PROPOSED LANDSCAPE AREAS AT CUL-DE-SAC ENTRANCE

EXHIBIT E C+RAChoi + Robles

Architecture, LLP

2251 HARBOR BAY PARKWAY ALAMEDA, CALIFORNIA 94502

TEL (510) 523-9123

DESCRIPTION OF



CHANGE USE PERMIT (CUP) FOR AHERN 2091 WEST AVE. 140TH SAN LEANDRO, CA

FILE NO: 201618.03

DATE ISSUED:


12/12/16 CUP PRE-APPLICATION 02/06/17 CUP APPLICATION $\sqrt{1}$ 03/14/17 CUP RESUBMITTAL


COPYRIGHT © 2016 ALL RIGHTS RESERVED

N:\CRA-CAD\201618.03 Ahern CUP Application\01 Dwgs 20161803 Ahern A21 Warehouse Flr and Elevation.aec


SHEET NO 05

OF 11 SHEETS

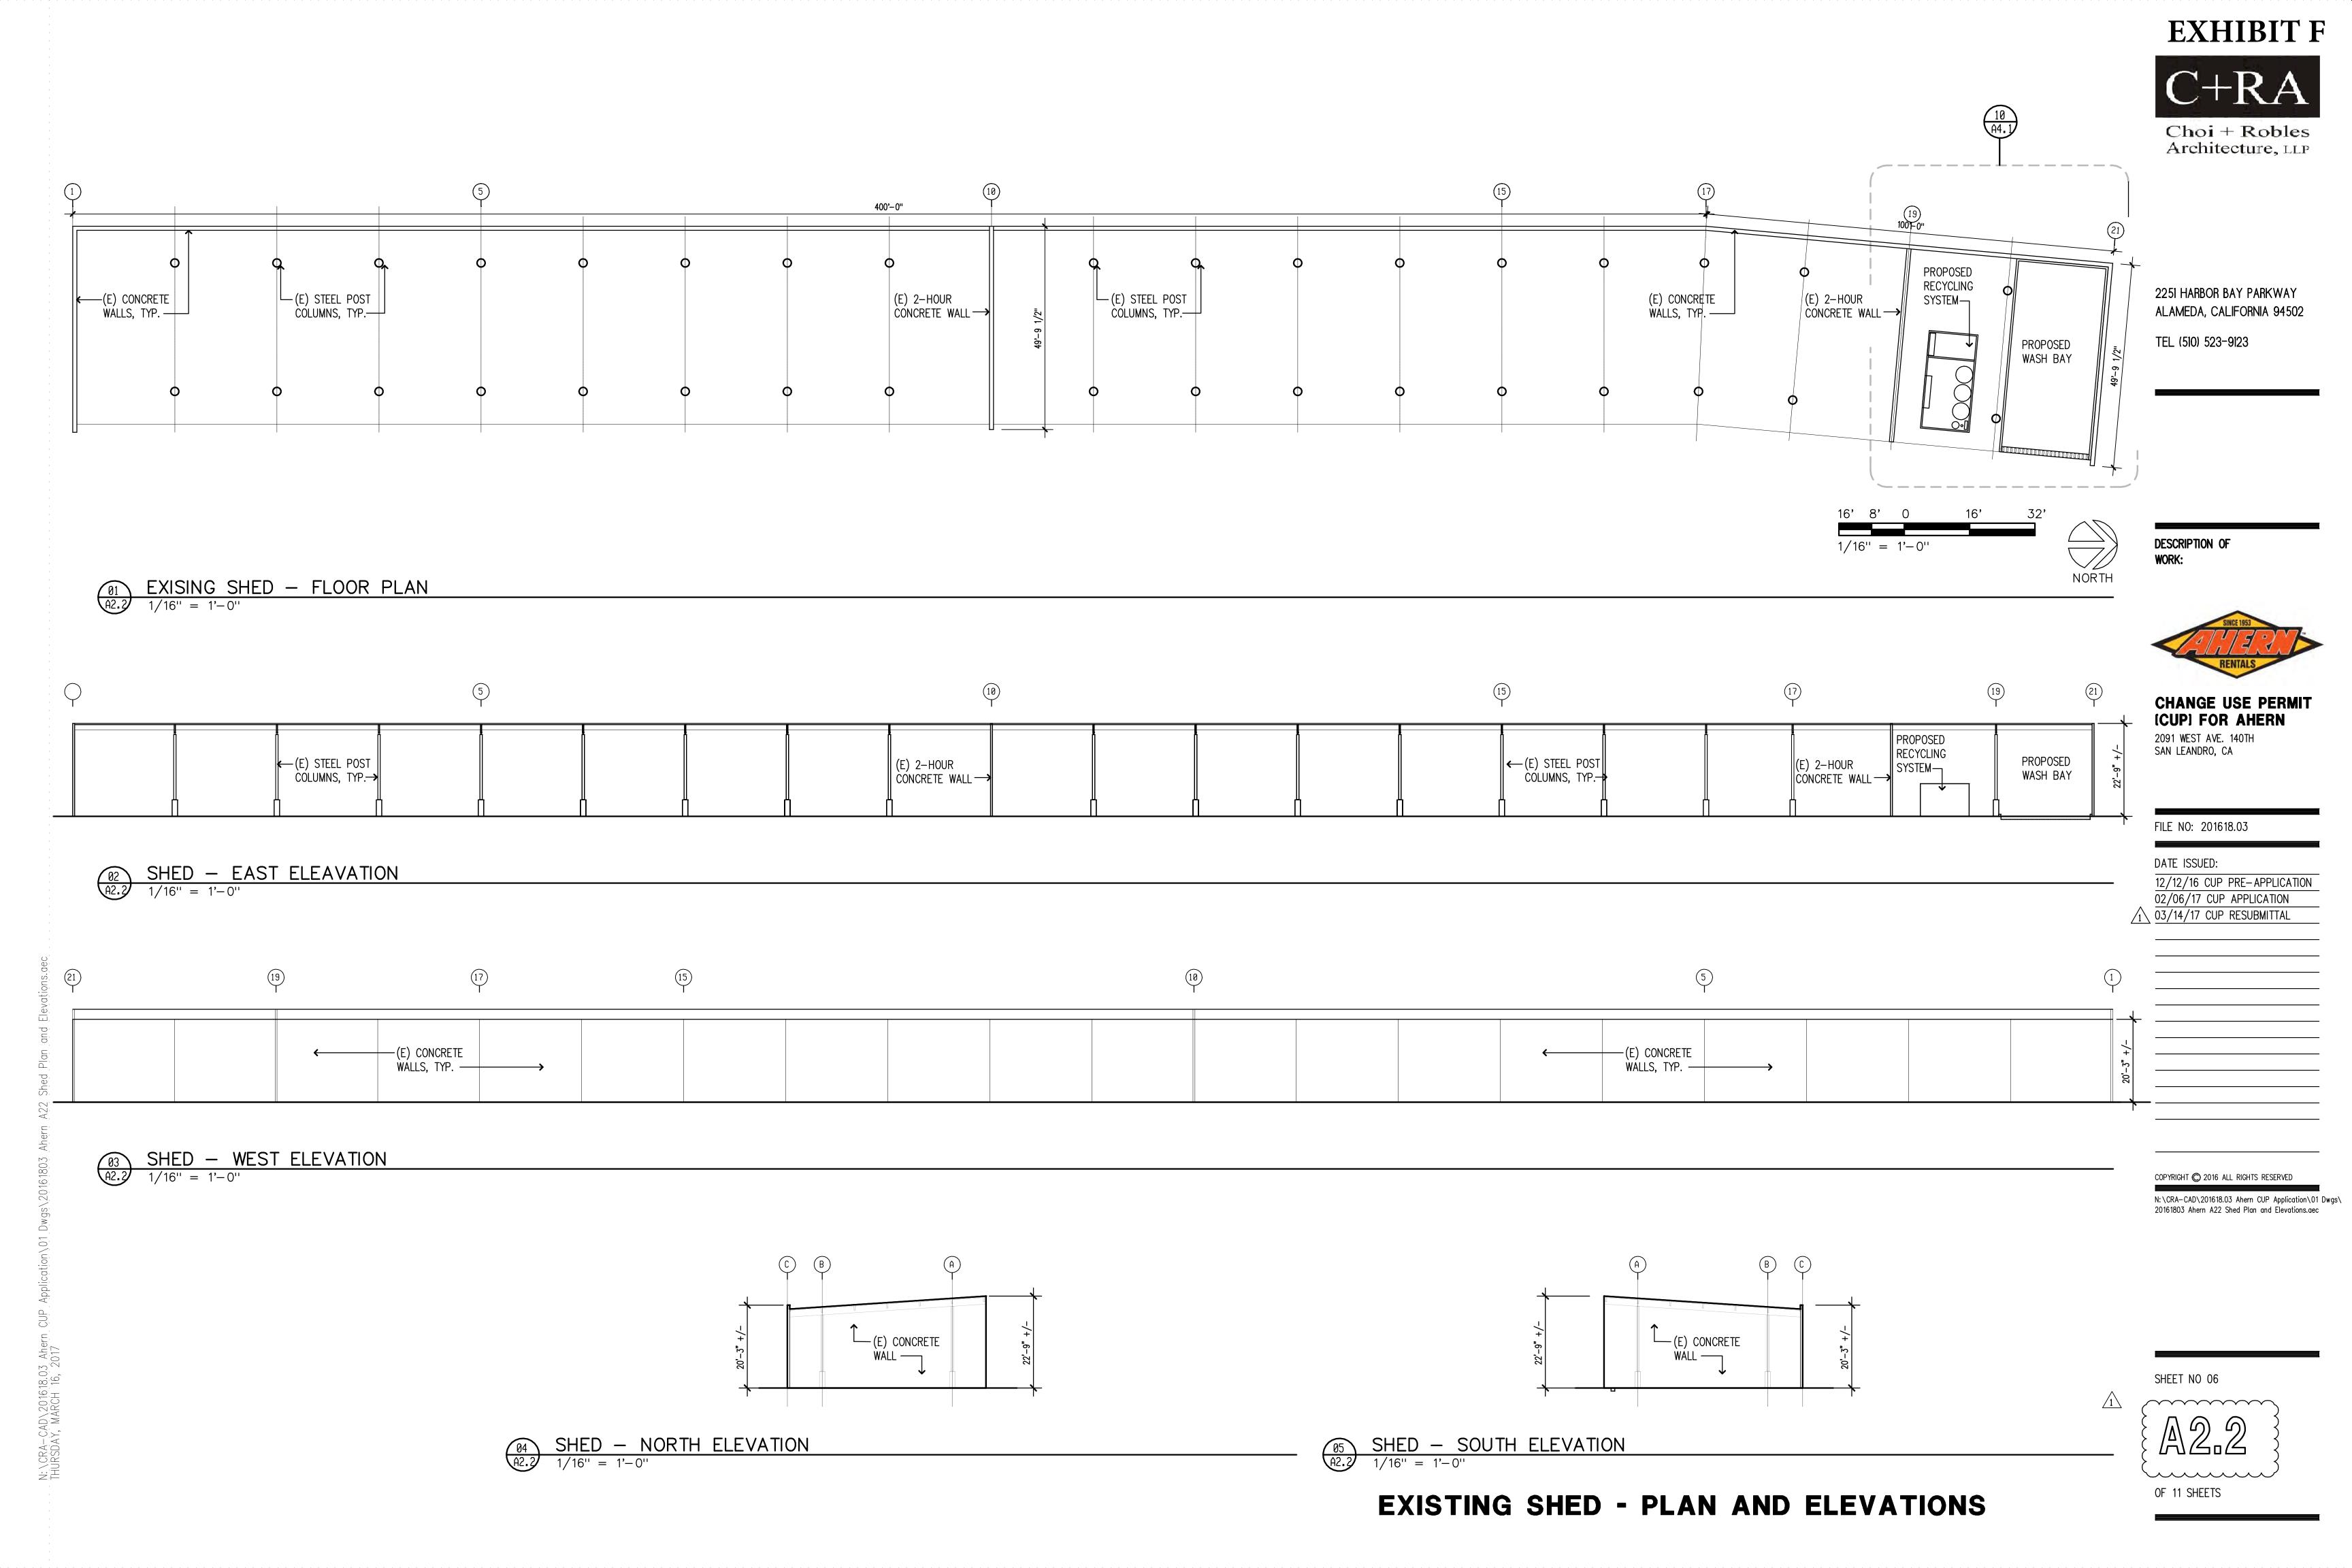

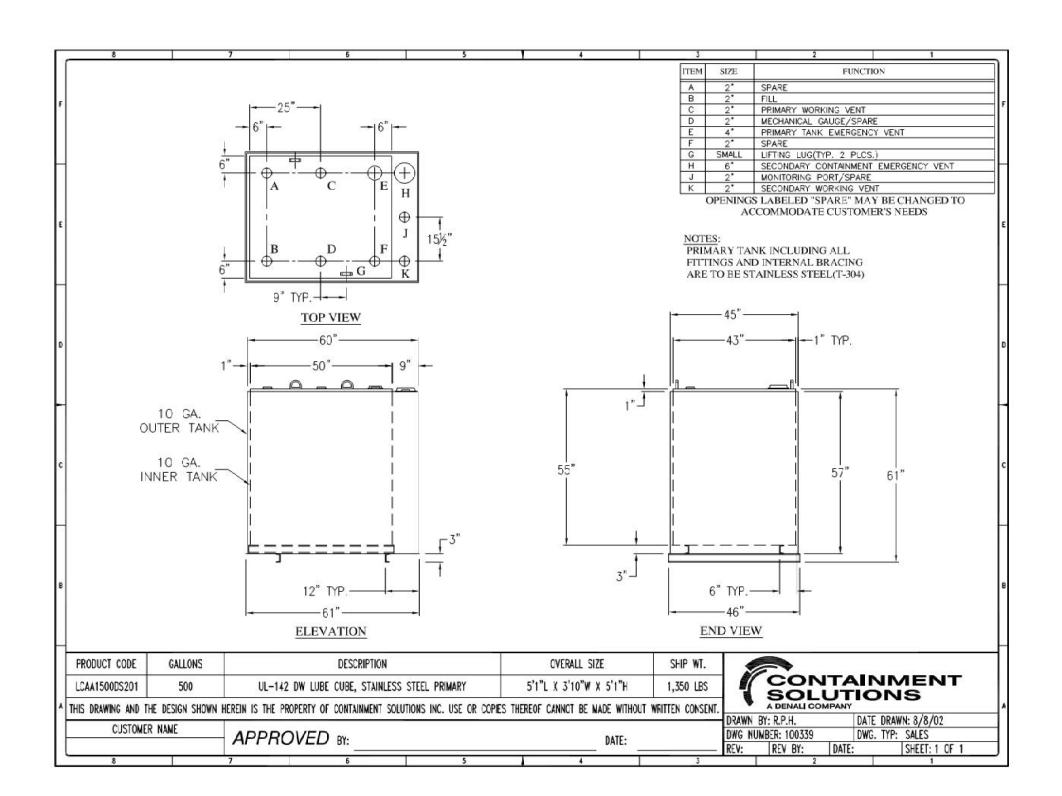

GAS- 500 GAL

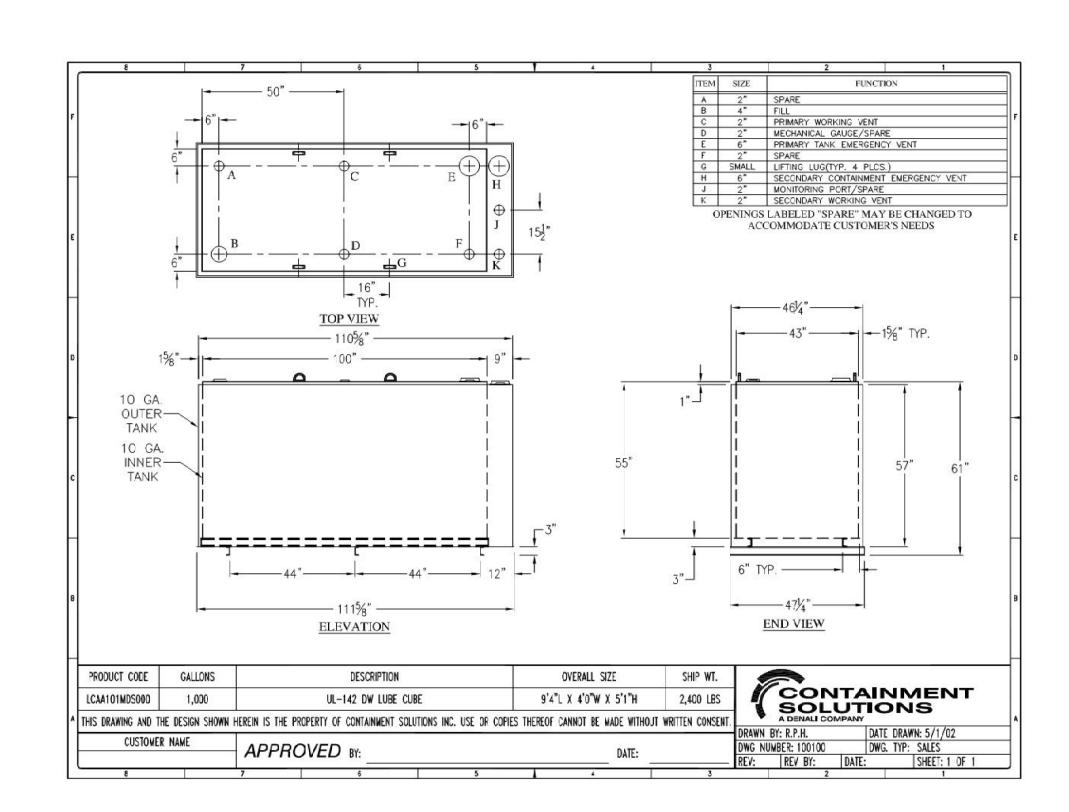

DIESEL- 1000 GAL

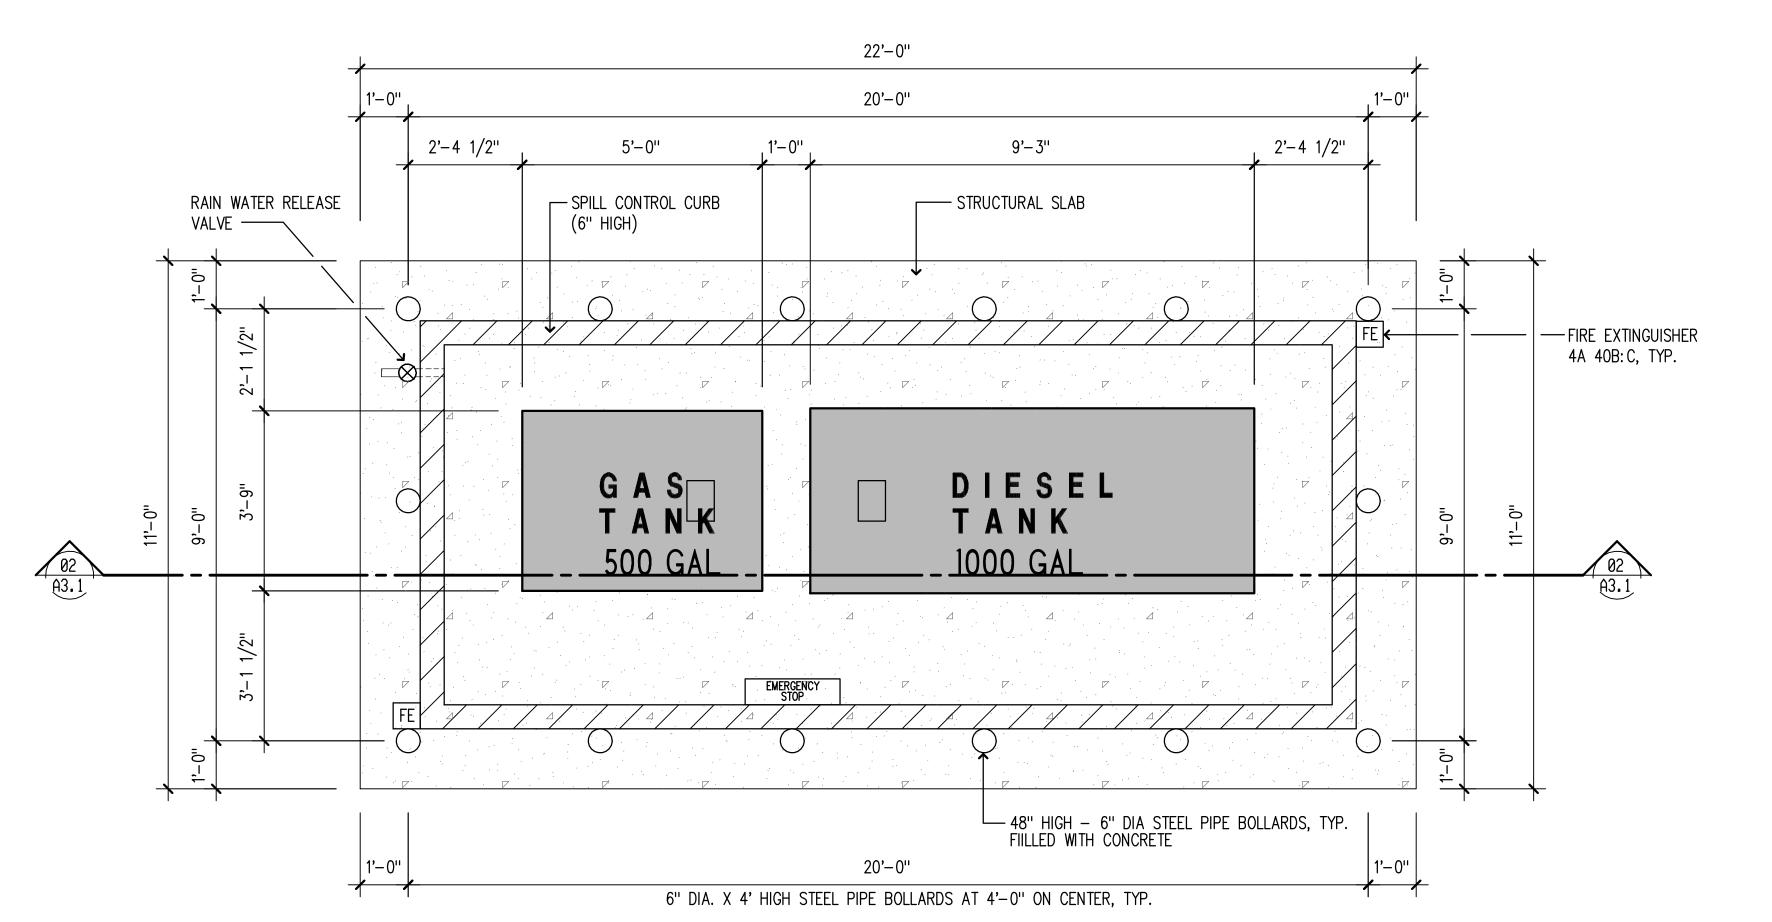


EXHIBIT G

Choi + Robles

Architecture, LLP

C+RA

2251 HARBOR BAY PARKWAY ALAMEDA, CALIFORNIA 94502


TEL (510) 523-9123

DESCRIPTION OF WORK:




CHANGE USE PERMIT (CUP) FOR AHERN 2091 WEST AVE. 140TH SAN LEANDRO, CA

FUELING STATION — FLOOR PLAN

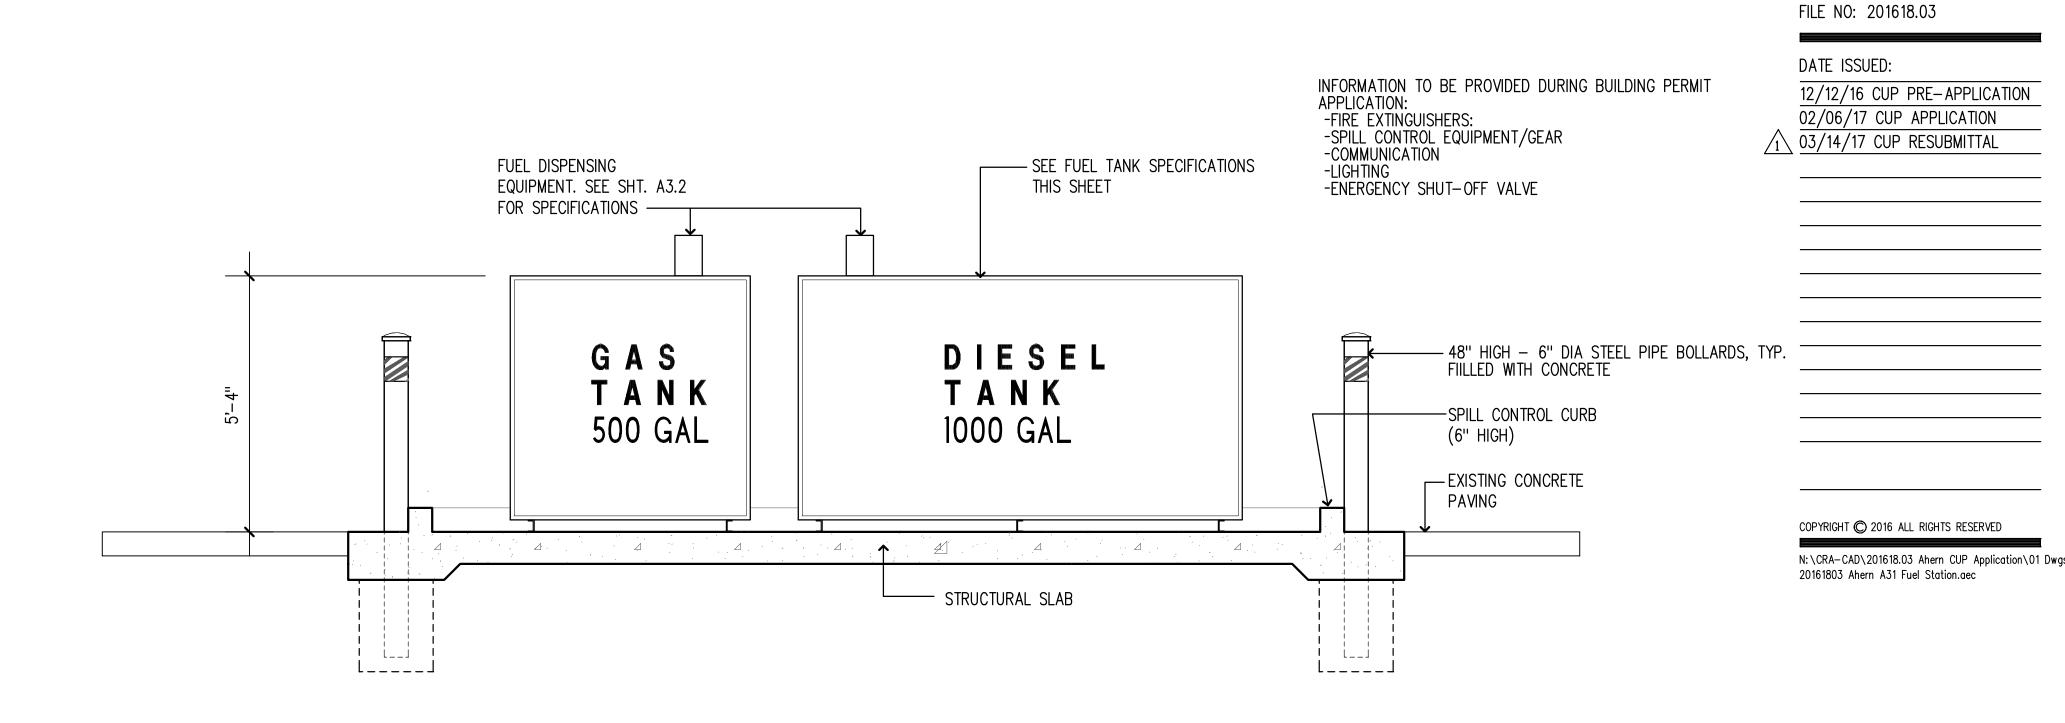

FUELING STATION — SECTION 1/2" = 1'-0"

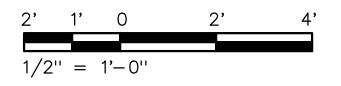

SHEET NO 07

A3.1

OF 11 SHEETS



EMERGENCY FUEL STOP


PROPOSED DISPENSING EQUIPMENT

If in doubl about the compatibility of a specific fluid, contact the supplier of the fluid to check for any adverse reaction to the following wetted materials.

Cast Iron Zinc Plated Steel Ceramic Aluminum

(FR701B anly)

Dimensions

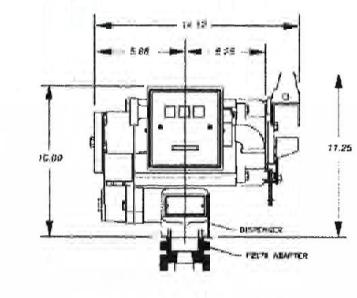

Refer to Owner's Operation & Safety Manual shipped with the pump and/or available for reference and

Motors that need repair should be taken to an authorized repair shop for service. Pumps must be thoroughly flushed and drained before being taken in for service.

Maximum ambient operating temperature Minimum ambient operating temperature Minimum Dry Vacuum


Minimum Suction Lift**

150 °F (66 °C)* -15 °F (-26 °C)* 12 Inches of mercury 15 Feel for Diesel. For gesoline see

1 Nominal flow rate at nominal voltage using a standard hose and manual nozzle with low viscosity * Consult factory for extreme temperature applications outside this range. ** The lift in feet is equivalent to the vertical distance from the surface of the fluid in the tank to the inlet of the pump. PLUS the friction losses through the vertical and horizontal runs of pipe, all elbows and

other fittings. The system should be designed to require a minimum amount of suction lift.

Flow Curve

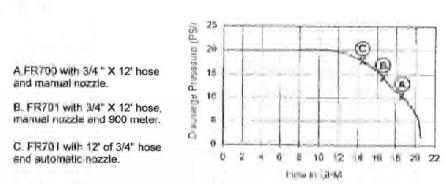

Nominal flow curve based on 3 feet suction in Actual flow rates obtained may very.

Fluid Compatibility

The 700B Series pumps are compatible with the following fluids:

Diesel, Gasoline, Kerosene, Mineral Spirits, Heptane, and Hexane.

Acetone Animonia Benzene, Bleach, Hydrochloric Acid Water, Ink, Tolulene, Aviation Gas, Jet Fuel

The 700B Earles pumps are NOT compatible with the following fluids:

Maximum outlet pressure Maximum flow rate (1) Maximum Recommended Viscosity of Pumpe

Available Options

No. of the last of		
Description	Adjustment to Shipping Weight (lbs.)	Adjustment to Shipping Weight (k
Upgrade to automatic nozzle from standard manual nozzle.	2.0	0.9
Unit supplied with 220 VAC - 50 Hz motor	-	-
Unit supplied with 220 VAC - 50/60 Hz	-	£
Unit equipped with meter registering liters in place of standard gallon meter.		-
	Upgrade to automatic nozzle from standard manual nozzle. Unit supplied with 220 VAC - 50 Hz motor Unit supplied with 220 VAC - 50/60 Hz motor Unit equipped with meter registering liters	Description Adjustment to Shipping Weight (Ibs.) Upgrade to automatic nozzle from standard manual nozzle. Unit supplied with 220 VAC - 50 Hz motor Unit supplied with 220 VAC - 50/60 Hz motor Unit supplied with meter registering liters

Accessories

Part Number

4200F9111	Nozzle Spout Hook (for automatic nozzles)
FRH07512	Buna-N hose 3/4" X 12' with static wire, 3/4" ferrules
1210KTF7019	Hydrosorb filter kit - 1200KTG9075 cast Iron 3/4" adaptor with F810HM0 filter
6U075	Manual unleaded nozzle with 3/4" inlet
NO75UAV10	Automatic unleaded nozzle with 3/4" inlet
700F2170	2" O.D. X 1" I.D. tank adapter
700KTF8598	Automatic nozzle retainer kit
712KTF9114	Universal nozzle boot & nozzle retainer, mounting plate to be attached to FR700B of FR701B pump, LESS vapor hose, vapor nozzle, valve & fittings
TH13	Pedestal Kit - Base, pedestal column & coupler for 1" pipe, less suction pipe and ur
1200KTF7018	Particulate Filter Kit - 1200KTG9075 cast iron 3/4" adapter with F180PM0 filter
70GKTF7024	Hydrosorb Filter Kit - 1200KTG9075 cast iron 3/4" adapter with F180PM0 filter for Model FR700
F180PC1	Clear Bowl, 10 micron prticulate filter w/ drain valve

F180PC1 Glear Bowl, 10 micron prticulate filter w/ drain valve F1B10PM1 Metal canister 10 Micron particulate filter w/ drain valve. Fits 1200KTG9075 filter head

Description

Performance

	20 PSI (1.52 BAR)
	20 GPM (75.7 LPM)
ped	Diesel Fuel

The Most Trusted name in Pumps & Meters FILL-PITE Saries 700B AC Powered Pumps Description of included Models Model Number Description Heavy Duty AC Utility Fump with manual nozzle and 3/4" X 12" hose. 48lbs 21.1kgs Heavy Duty AC Utility Pump with manual nozzle, 3/4" X 12' hoise and Model 807C meter installed. Safety Listings File Guide Approval Organization Mark Organization Description Underwriters Laboratories Inc., a nationally recognized independent organization for testing of products to ensure public safety Recognized MH7817 RCRX and accepted in USA, Canada and other countries. Indicates compliance with applicable European etandards and the motor is rated as explication proof under those standards.

EXHIBIT H

Choi + Robles

Architecture, LLP

2251 HARBOR BAY PARKWAY ALAMEDA, CALIFORNIA 94502

TEL (510) 523-9123

DESCRIPTION OF



CHANGE USE PERMIT (CUP) FOR AHERN 2091 WEST AVE. 140TH SAN LEANDRO, CA

FILE NO: 201618.03

DATE ISSUED: 12/12/16 CUP PRE-APPLICATION 02/06/17 CUP APPLICATION

1 03/14/17 CUP RESUBMITTAL

COPYRIGHT © 2016 ALL RIGHTS RESERVED

20161803 Ahern A31 Fuel Station.aec

N:\CRA-CAD\201618.03 Ahern CUP Application\01 Dwgs\


SHEET NO 08

OF 11 SHEETS

FUEL DISPENSING EQUIPMENT LITERATURE

Australian Certification Program, Certified under the Australian Certification Program under Aus EX 3620 as Series 700 (230 V, 76 LPM,

heavy duty)

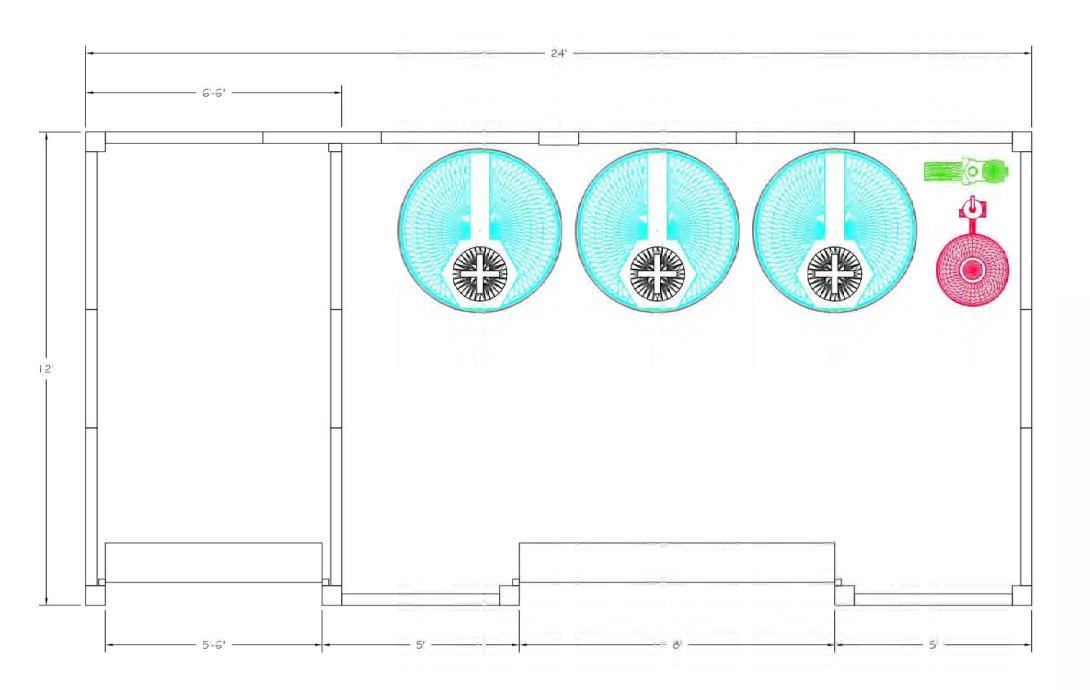



Ahern Rentals Recycler information

Our water recycling system is a closed loop system. All water used is captured, filtered, and reused enabling the operator to monitor and control the water used to clean a variety of equipment. It operates on single phase power, 220 volt. 25'-0''

- NEW TRENCH DRAIN

WITH SUMP PUMP

(N) WASH BAY

- NEW 6" X 6" CONCRETE

WASH BAY / WATER RECYLING SYSTEM IN (E) SHED

1/4" = 1'-0"

CURB (3 SIDES) —

EXISTING CONCRETE

The system has a total capacity of 2250 gallons of water through a variety of holding tanks. The system settles the heavier particles in the water and polishes the final stage of water insuring that clean and clear water is used for washing. Ninety percent of all water is captured and reused while typically ten percent is lost in evaporation.

The closed loop system with proper maintenance removes mud, oils, and heavy particles contained in the washing system.

Attached is a elevation sheet of one of our typical systems, and a water flow chart for


If you have any questions I would be pleased to help.


Sincerely yours, Project Manager Ahern Rentals 8250 Eastgate Road Henderson, NV 89015 702-210-2509 cell

genec/a)ahern.com

WATER RECYCLING SYSTEM PLAN

WATER RECYCLING SYSTEM - DESCRIPTION

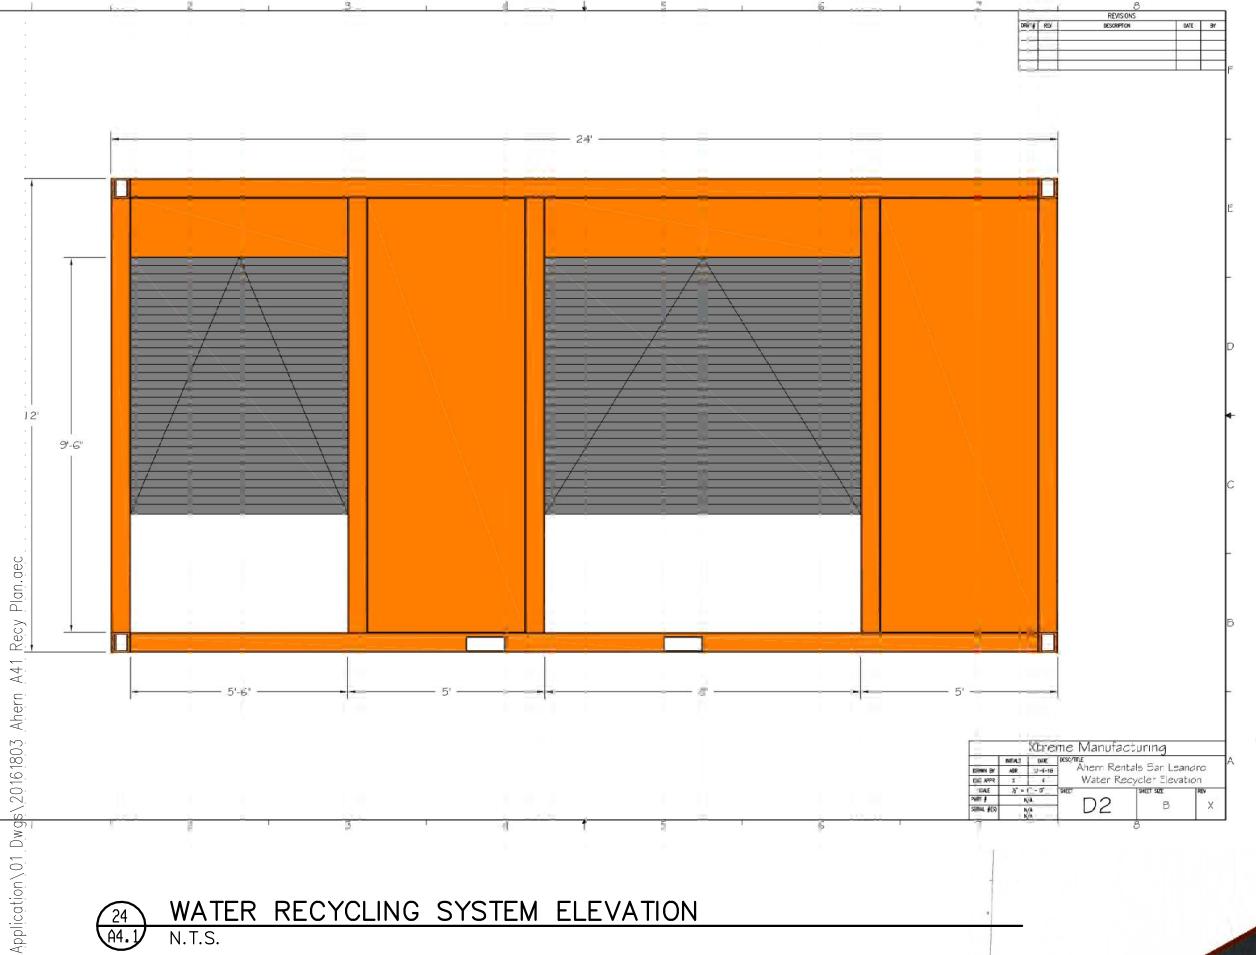

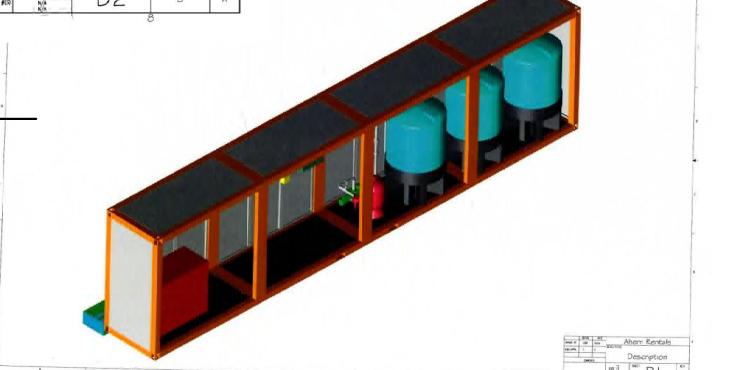

(N) WATER

SYSTEM

RECYCLING

FILE NO: 201618.03 DATE ISSUED: 12/12/16 CUP PRE-APPLICATION 02/06/17 CUP APPLICATION $\sqrt{\frac{03}{14}/17}$ CUP RESUBMITTAL

1/4'' = 1'-0''

SHEET NO 09

OF 11 SHEETS

WASH BAY AND WATER RECYCLING SYSTEM

— EXISTING

COLS. TYP.

SEE DETAIL 22/A4.1


EXHIBIT I Choi + Robles Architecture, LLP 2251 HARBOR BAY PARKWAY ALAMEDA, CALIFORNIA 94502 TEL (510) 523-9123 DESCRIPTION OF **WORK: CHANGE USE PERMIT** (CUP) FOR AHERN 2091 WEST AVE. 140TH SAN LEANDRO, CA

COPYRIGHT © 2016 ALL RIGHTS RESERVED

20161803 Ahern A41 Recy Plan.aec

N:\CRA-CAD\201618.03 Ahern CUP Application\01 Dwgs

ISOMETRIC (SIM)

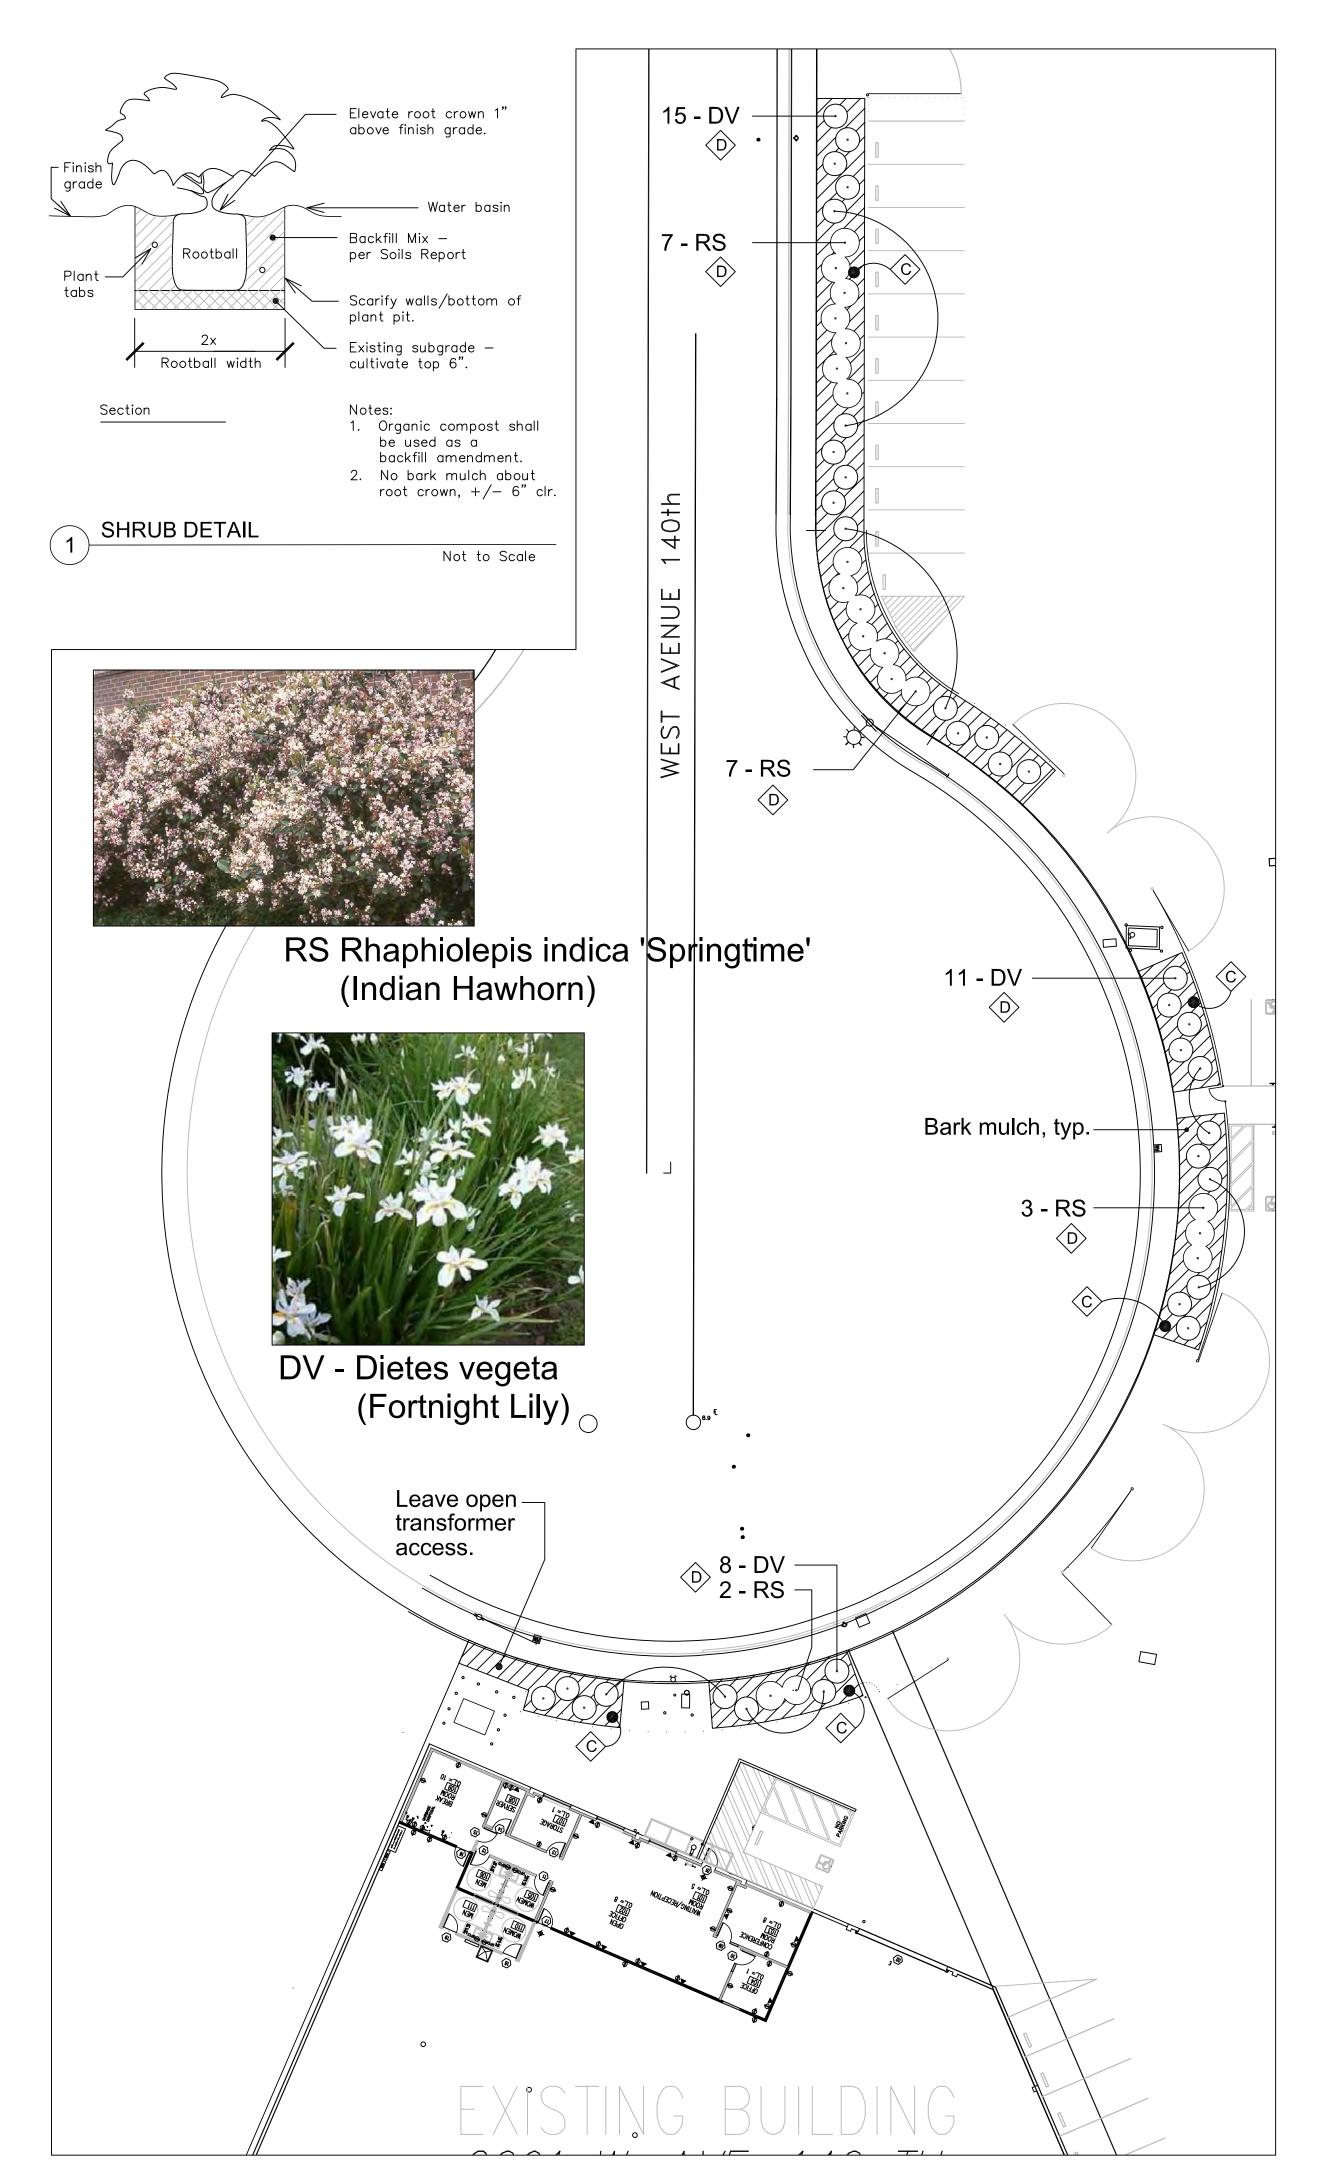

Scale: 1" = 20' - 0"

ENLARGEMENT PLANTING PLAN

PLANT LEGEND

SYM.	QTY.	SIZE	WUCOLS	BOTANICAL NAME	COMMON NAME	HEIGHT X	O.C. SPACING	
			RATING	SHRUBS		WIDTH	(MAXIMUM)	
DV	34	5 G	LOW	DIETES VEGETA	FORTNIGHT LILY	4' X 5'	AS SHOWN	
NW	12	5 G	LOW	NERIUM OLEANDER 'WHITE'	WHITE OLEANDER	10' X 12'	AS SHOWN	
RS	19	5 G	LOW	RHAPHIOLEPIS INDICA 'SPRINGTIME'	INDIAN HAWTHORN	4' X 6-7'	AS SHOWN	
				MISCELLANEOUS				

"WALK-ON" BARK MULCH, 3" LAYER

DESIGN KEY

- A This area under separate submission.
- B Proposed Oleander shall be manually watered. No automatic irrigation system servicing this area.
- Soil Testing Laboratory shall run tests to ensure existing soil permitted as a viable planting medium. All deleterious material (i.e. concrete, base rock, sterilized soil, etc.) shall be removed and replaced with approved import soil no exceptions.
- Planters along the cul-de-sac shall be serviced by an automatic, low flow, irrigation system. Irrigation designer shall meet all MWELO requirement/regulations. Irrigation design by others.

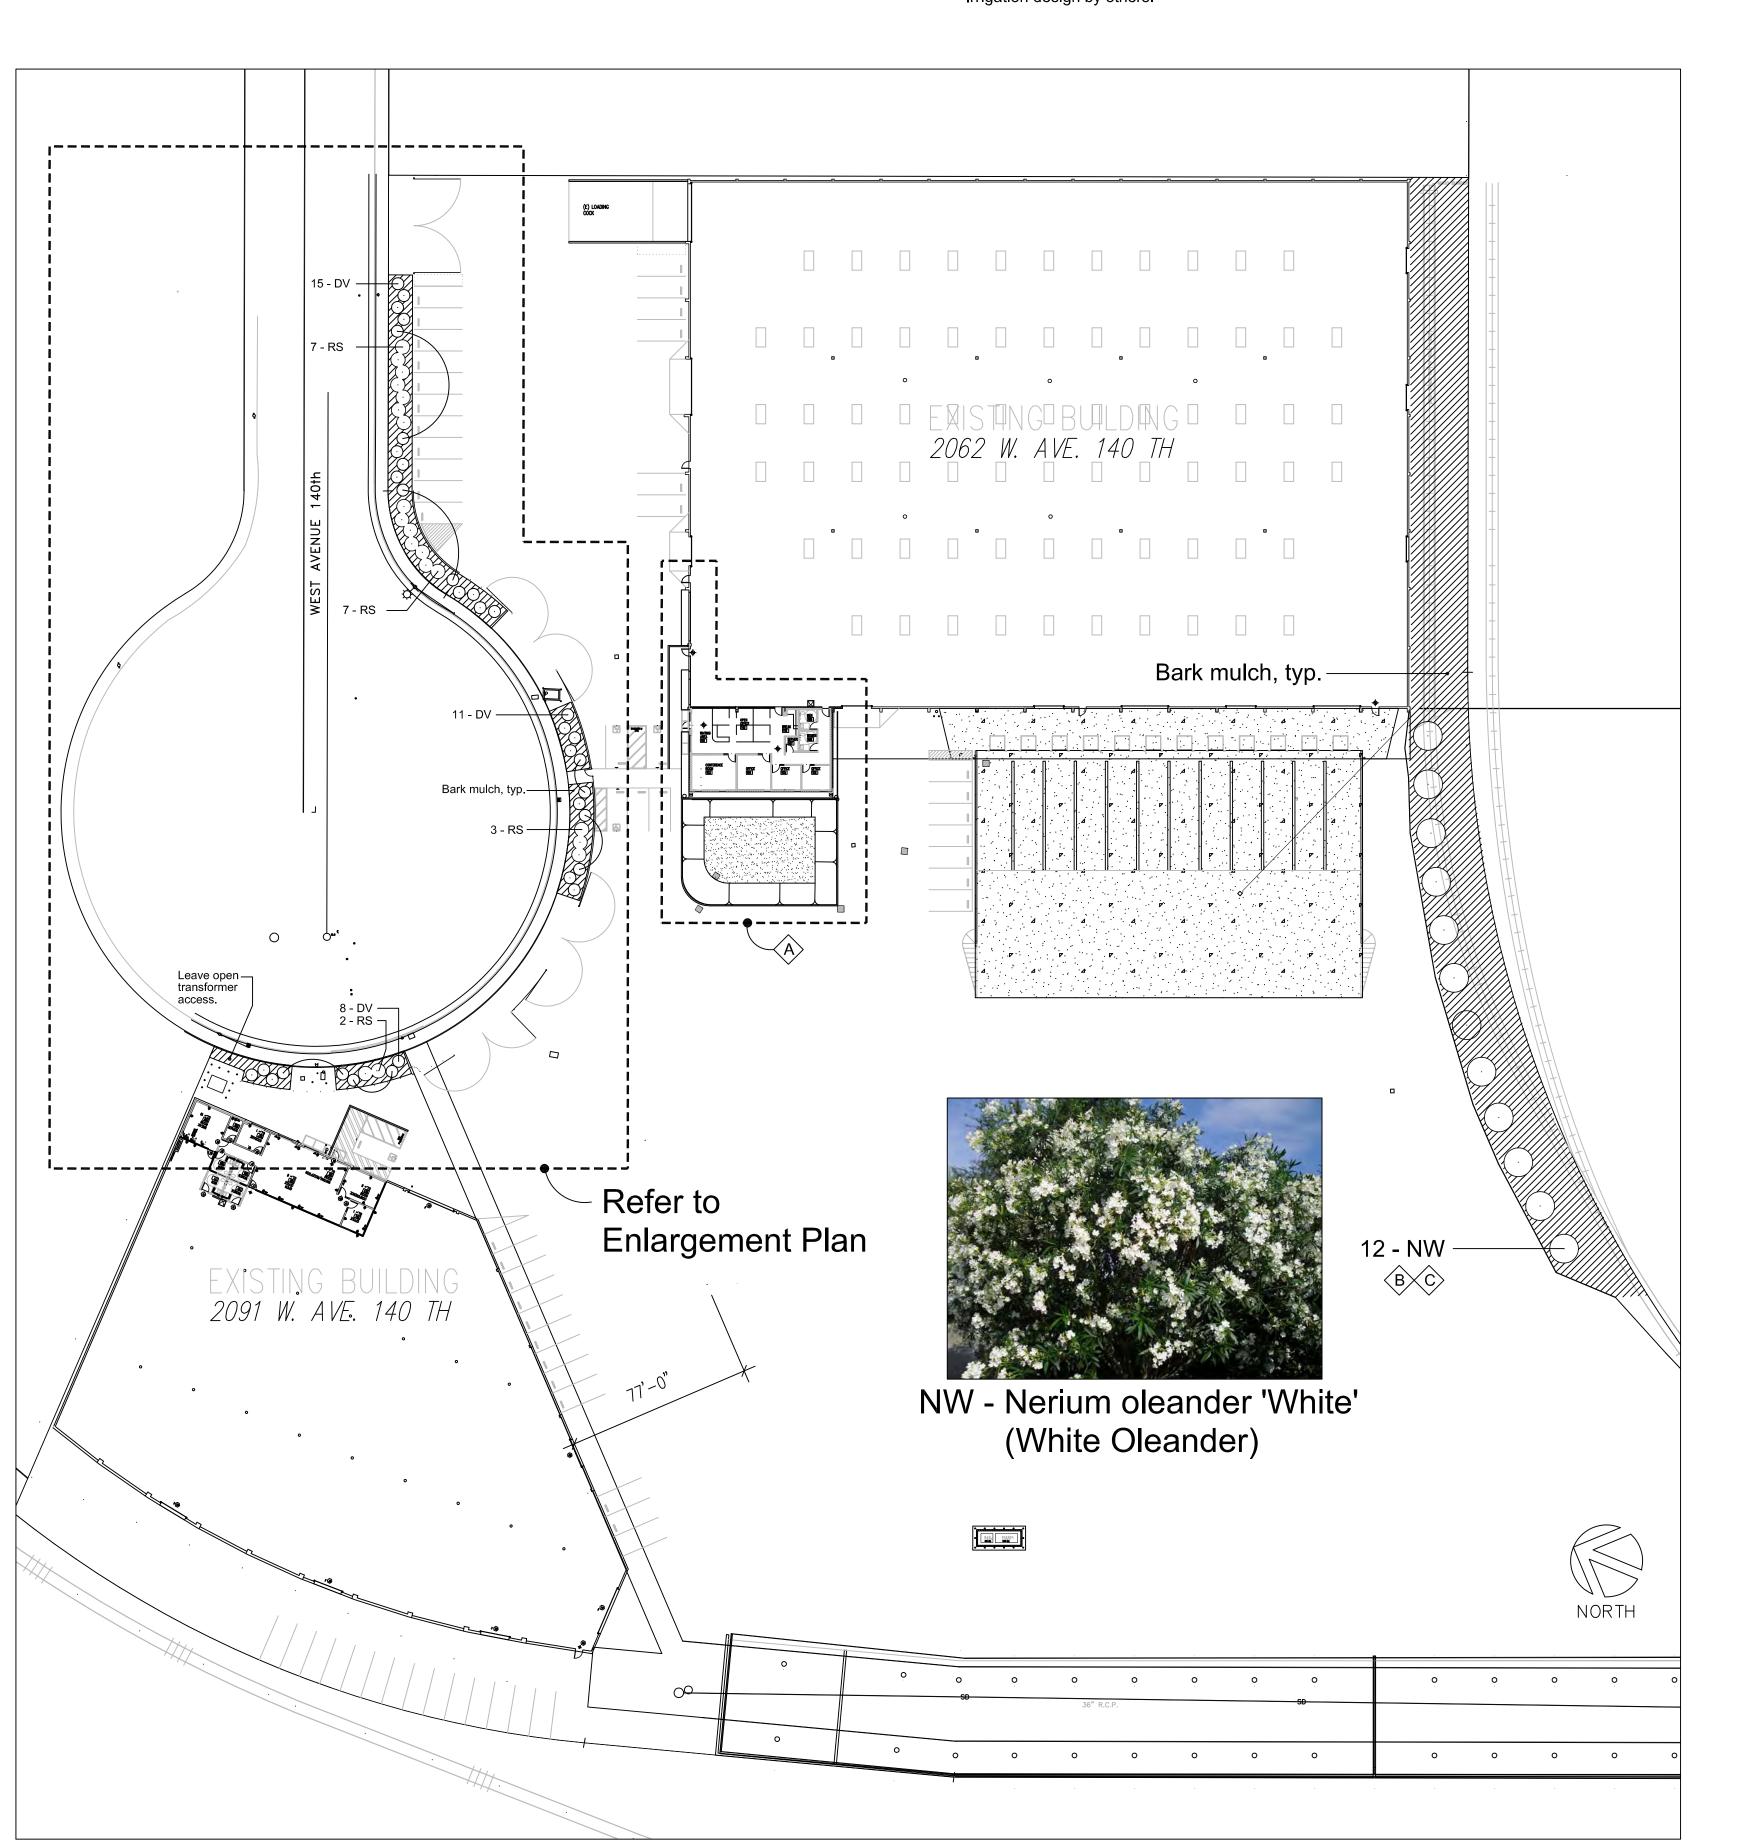


EXHIBIT J



2251 HARBOR BAY PARKWAY ALAMEDA, CALIFORNIA 94502 TEL (510) 523-9123 WWW.CRA-ARCH.COM

Randy DeValle

Landscape Architect CA License #2260 P.O. Box 2641 Castro Valley, CA. phone/fax (510) 581-4151





CHANGE USE PERMIT (CUP) FOR AHERN

2091 WEST AVE. 140TH SAN LEANDRO, CA

DATE ISSUED

2/2/17 CUP APPLICATION

BUILDING 2091

COPYRIGHT © 2016 ALL RIGHTS RESERVED

PLANTING PLAN

EET NO 10

OF 11 SHE

Scale: 1" = 40' - 0"

