

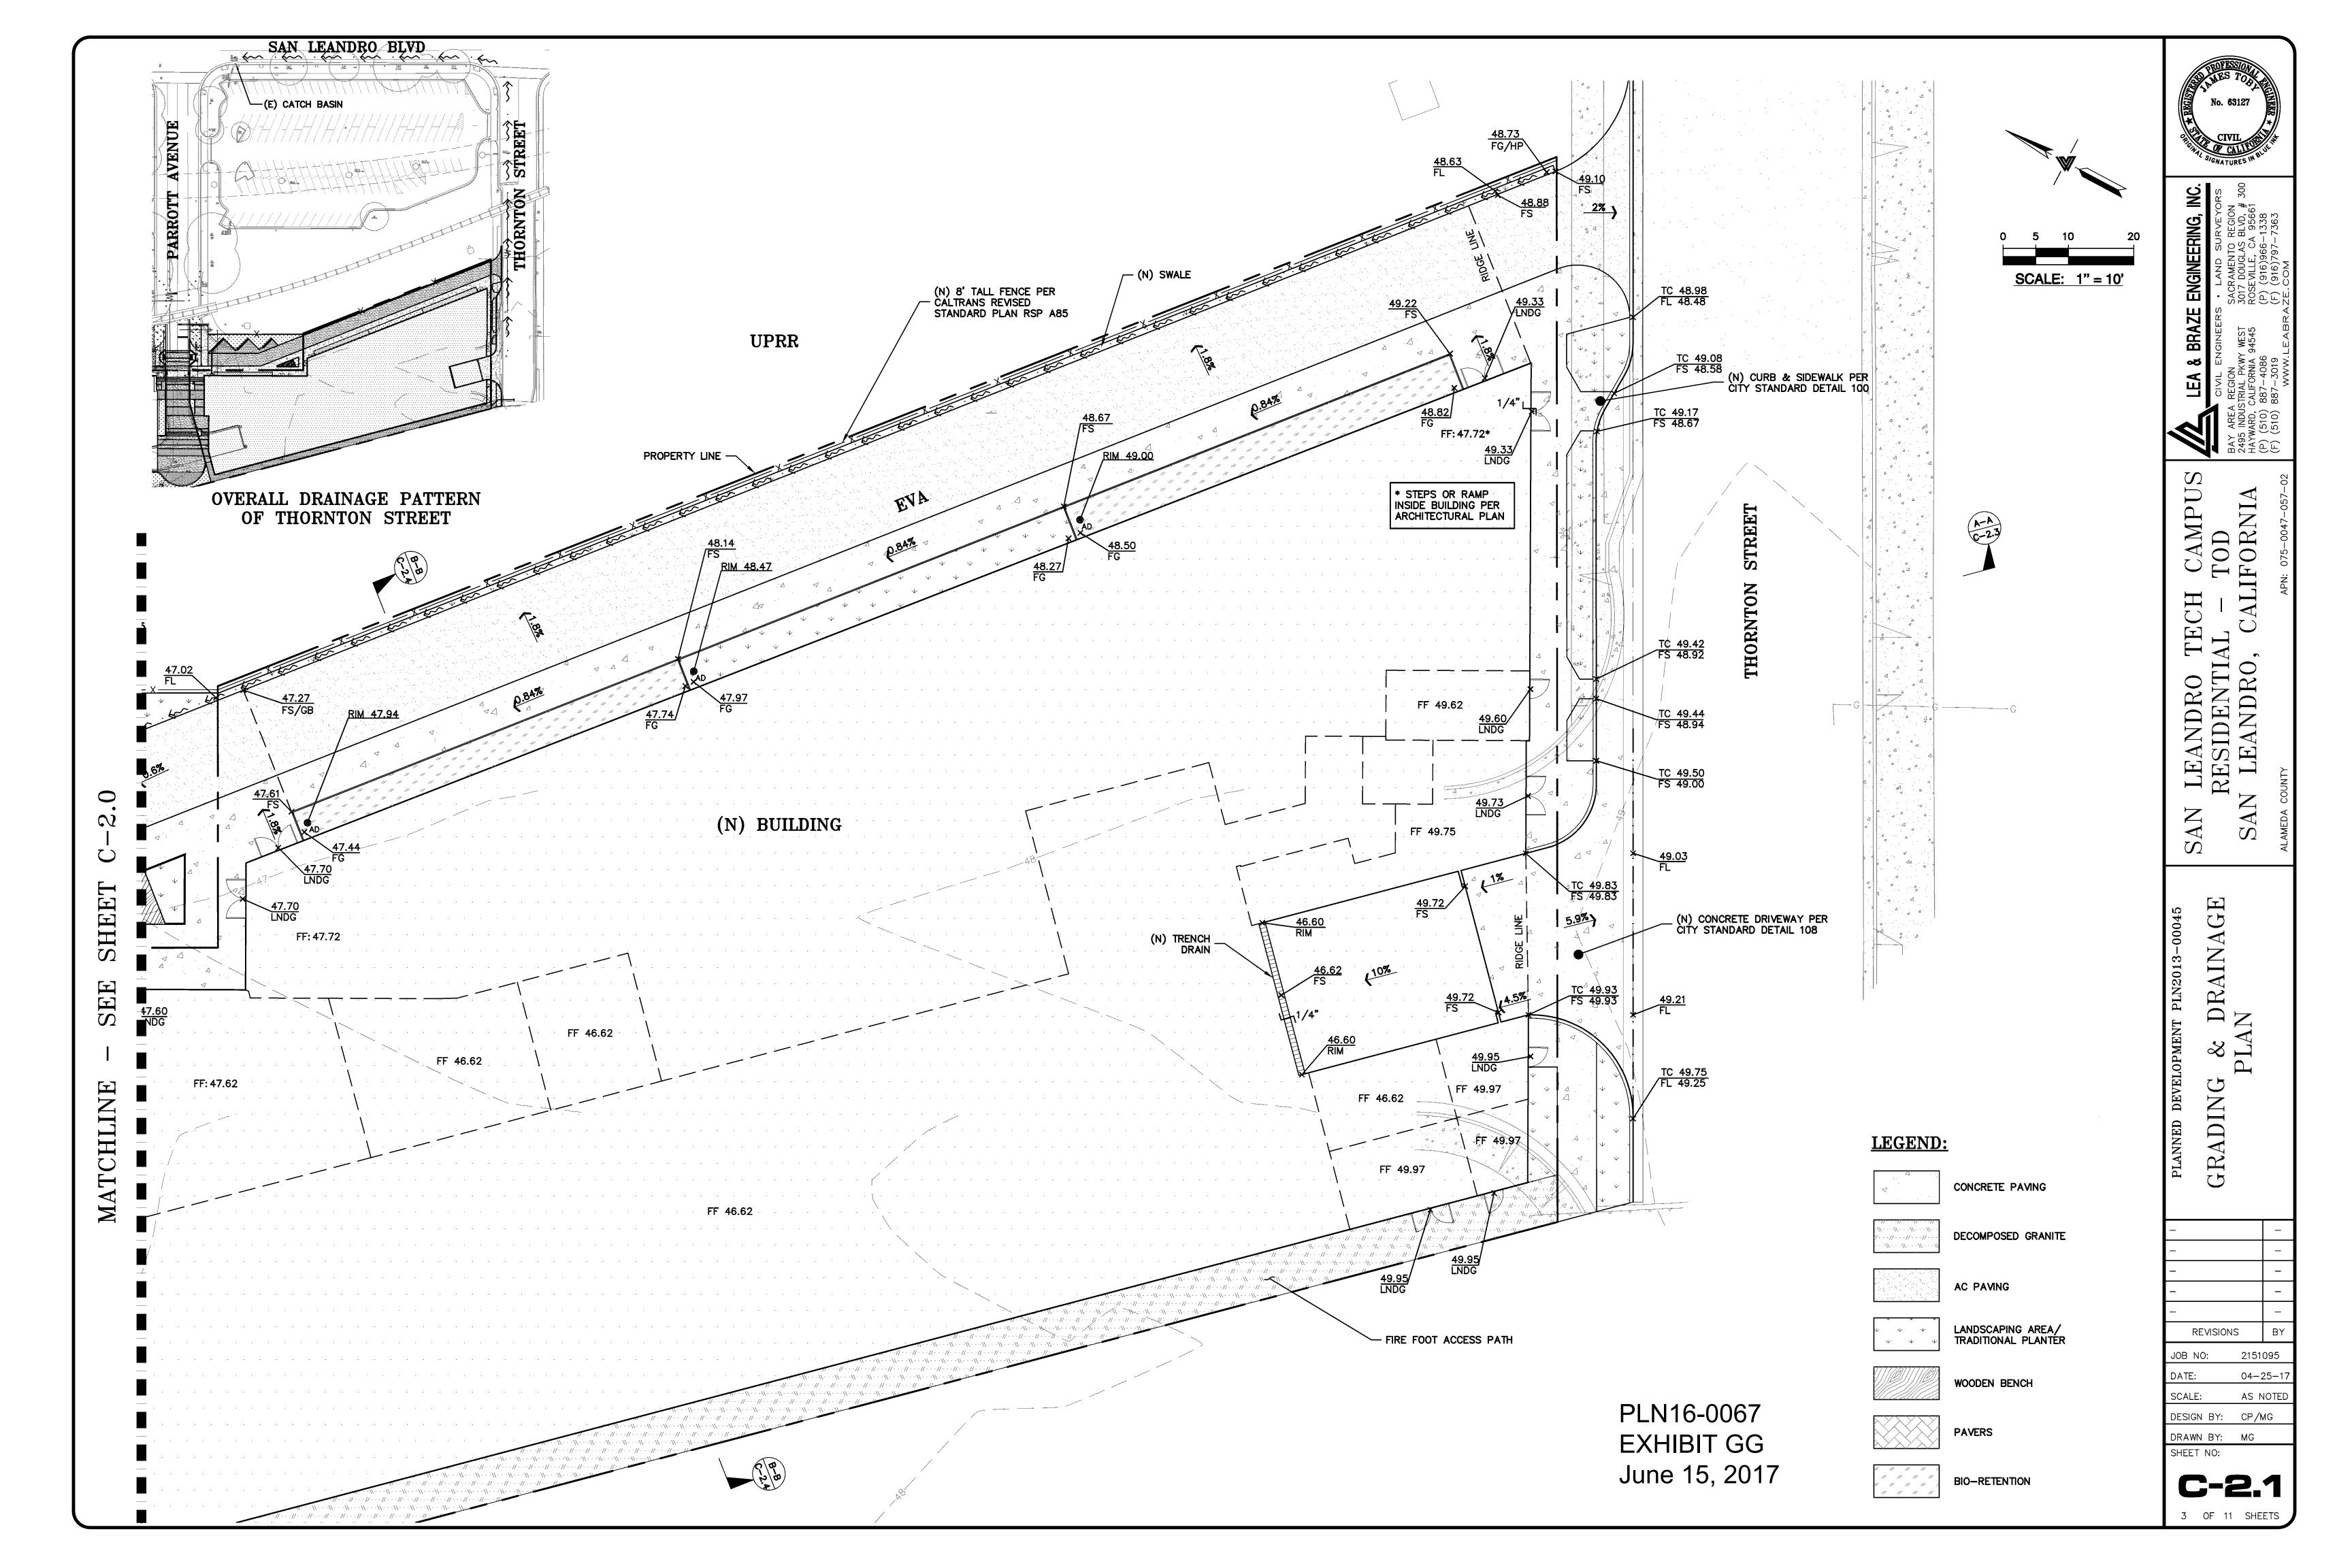
H CAMPUS
- TOD
ALIFORNIA

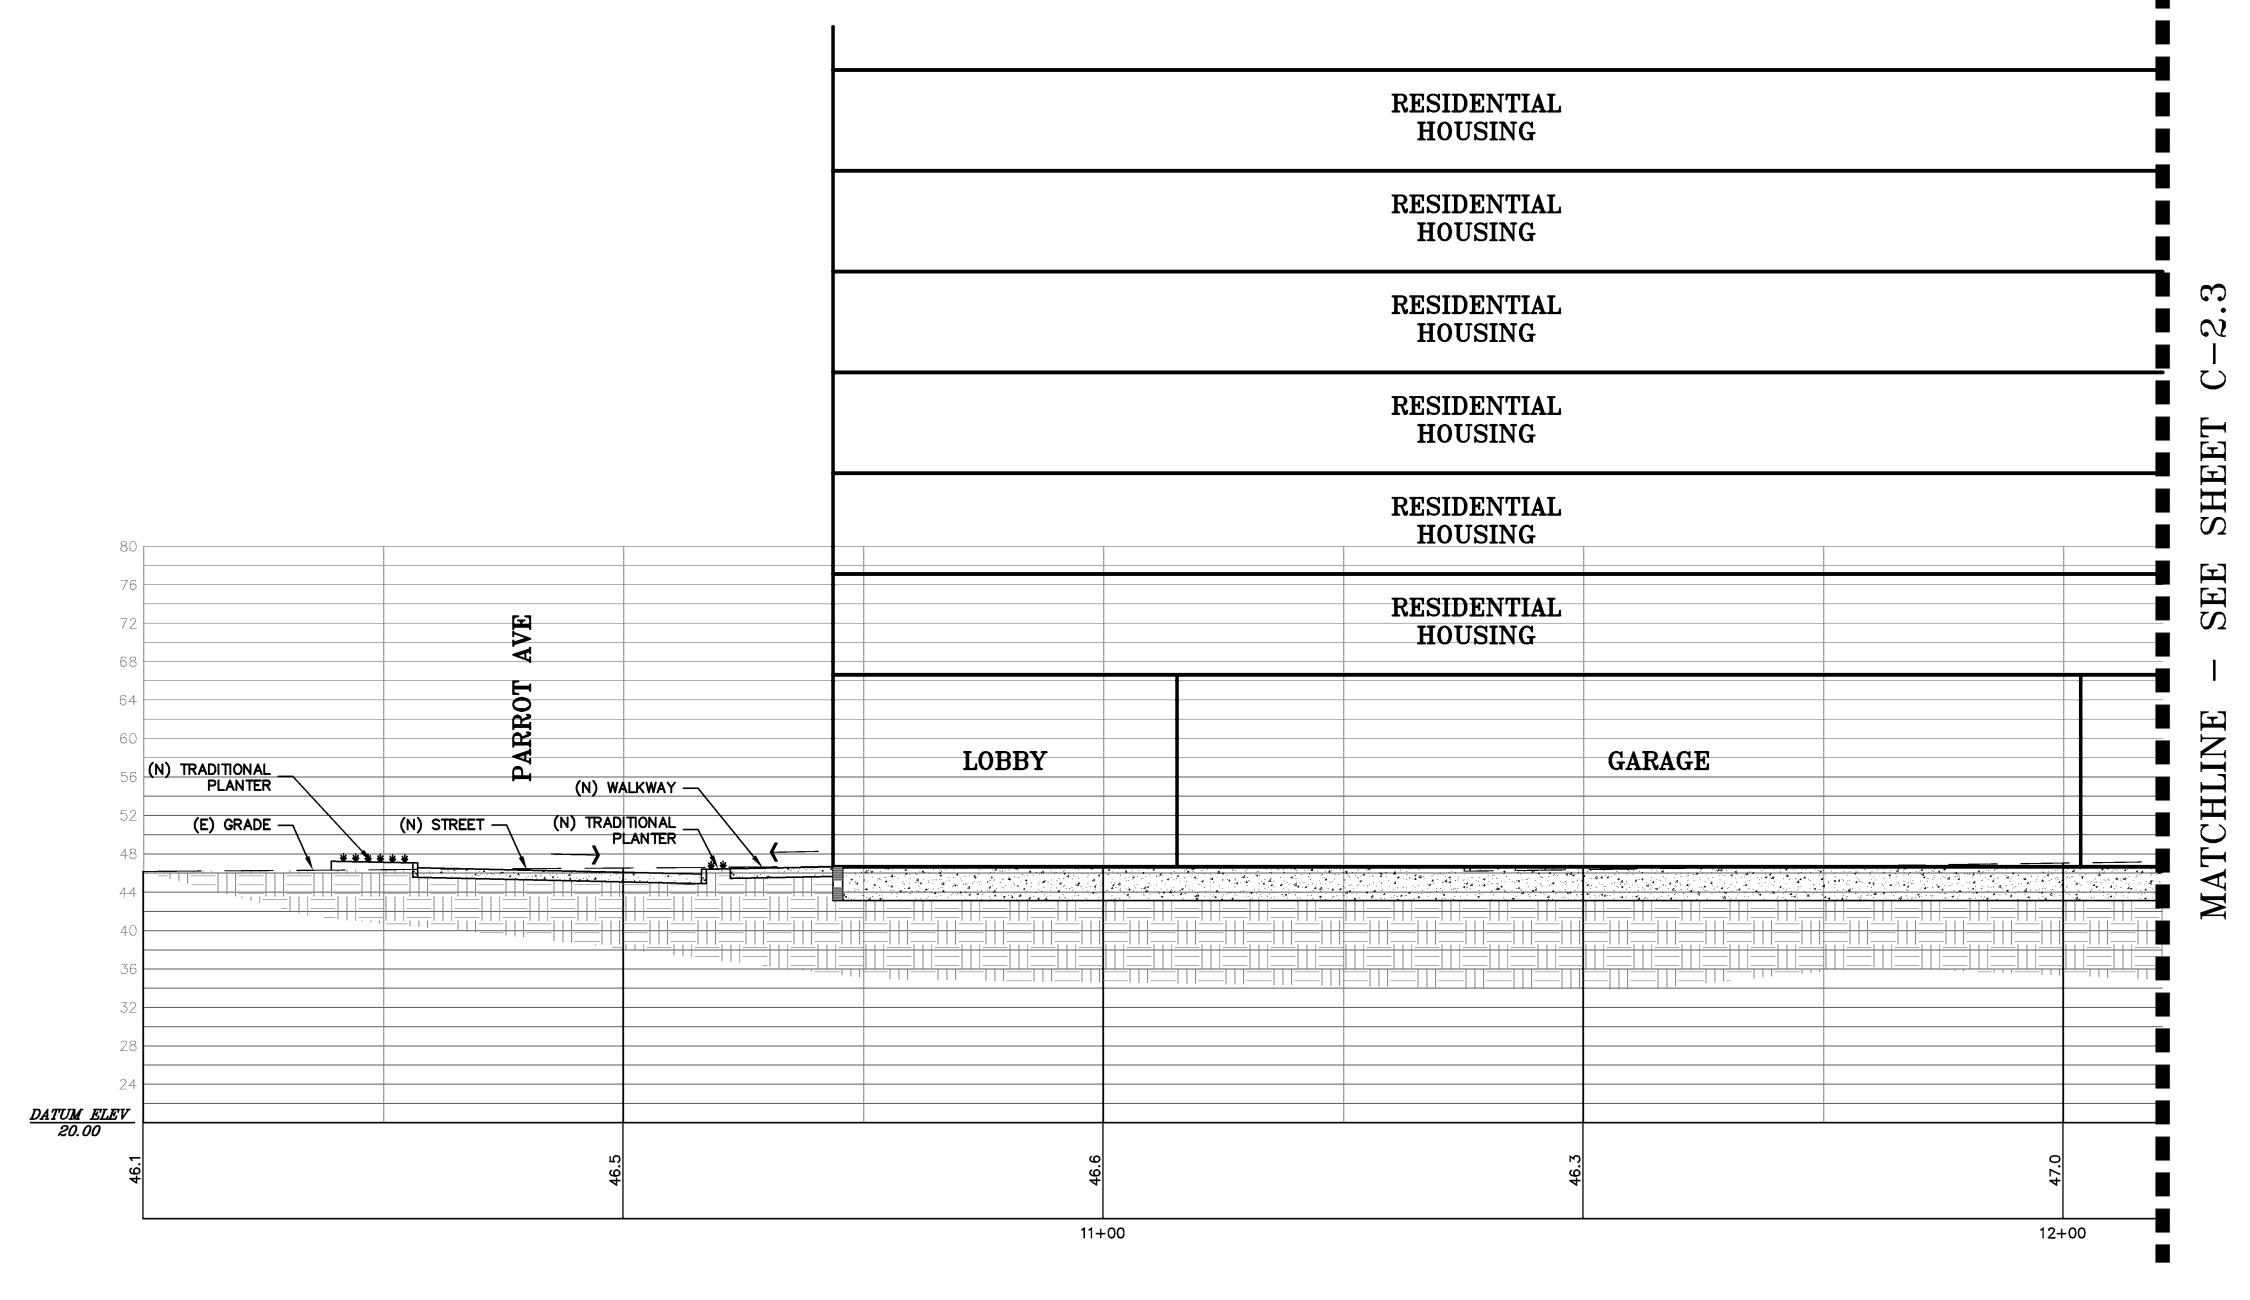
k & DRAINAGE PLAN

REVISIONS JOB NO: 2151095 04-25-1

AS NOTED DESIGN BY: CP/MG DRAWN BY: MG SHEET NO:

C-2.0 2 OF 11 SHEETS





SITE SECTION A-A

HORIZ. & VERT. SCALE: 1" = 10'

PLN16-0067 EXHIBIT HH June 15, 2017 No. 63127

No. 63127

CIVIL

SIGNATURES IN BLUE

S - LAND SURVEYORS
SACRAMENTO REGION
3017 DOUGLAS BLVD, # 300
ROSEVILLE, CA 95661
(P) (916)966-1338
(F) (916)797-7363

AY AREA REGION
SACRAME
495 INDUSTRIAL PKWY WEST
AYWARD, CALIFORNIA 94545
P) (510) 887-4086
P) (510) 887-3019
(F) (916)

TOD

BAY AREA RE
2495 INDUSTRIA
HAYWARD, CALI
(P) (510) 887
(F) (510) 887

SAN LEANDRO TECH RESIDENTIAL – SAN LEANDRO, CAL

SITE SECTIONS

- - - - - - REVISIONS BY

JOB NO: 2151095

DATE: 04-25-17

SCALE: AS NOTED

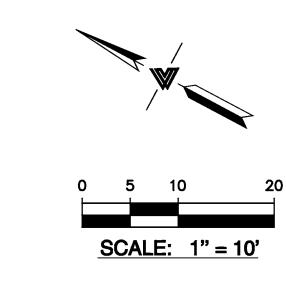
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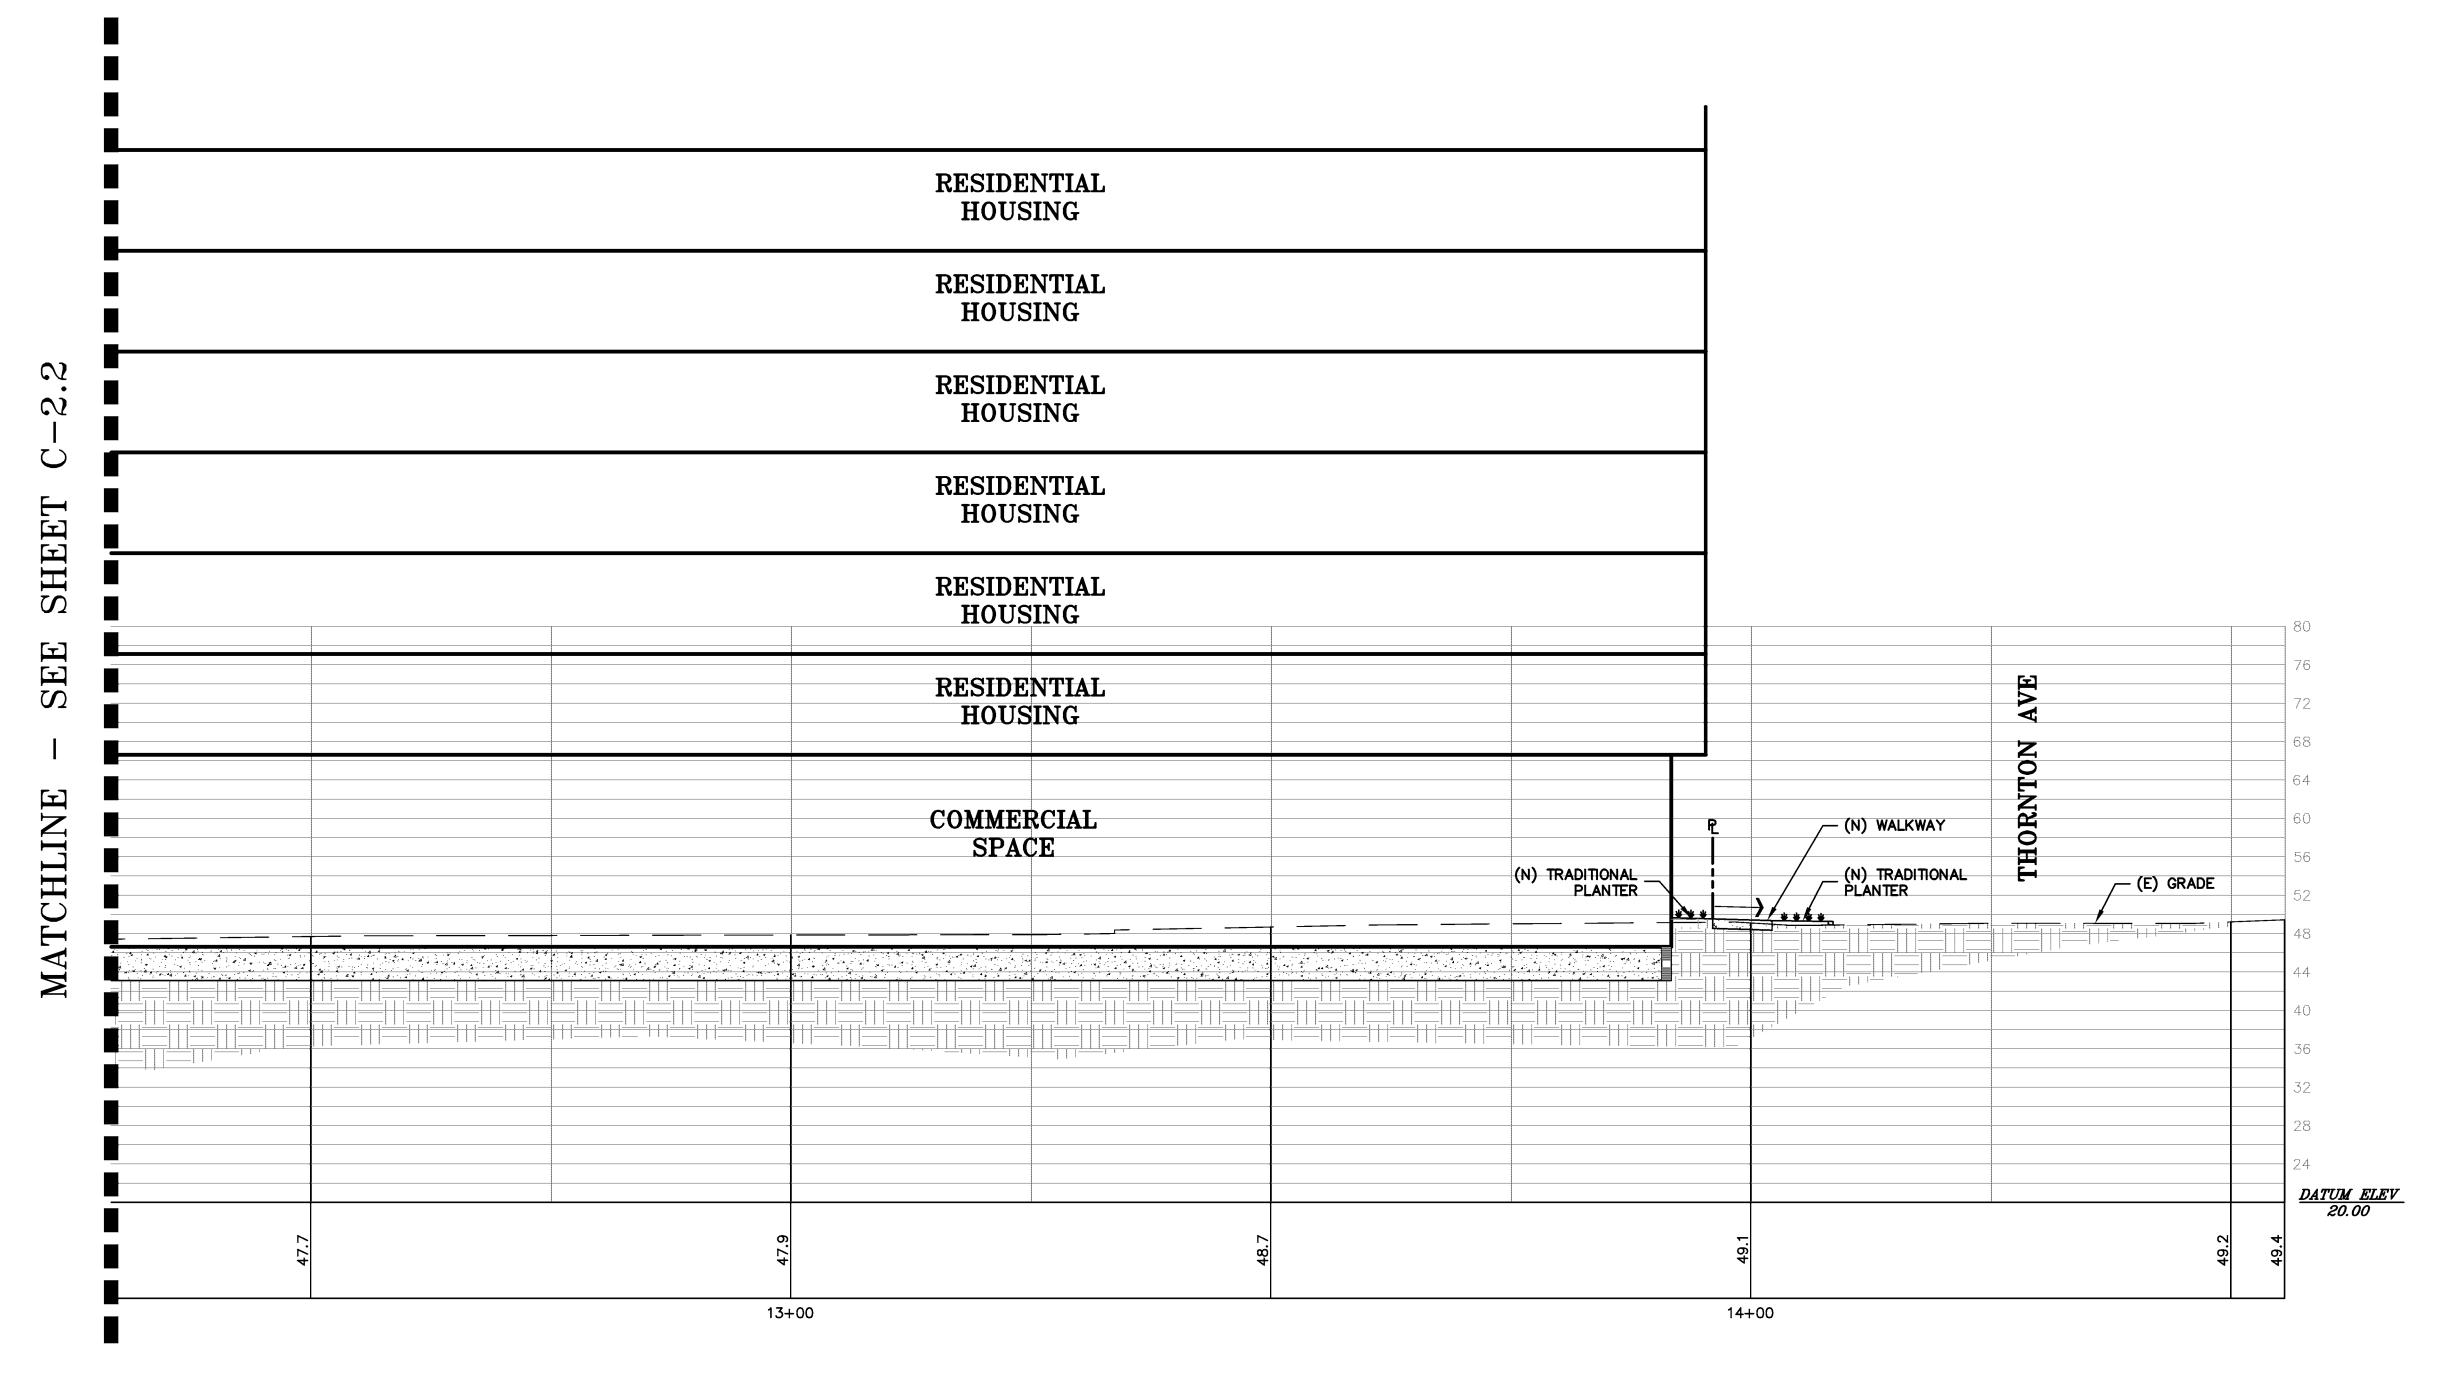
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DRAWN BY: MG

SHEET NO:








SITE SECTION A-A
HORIZ. & VERT. SCALE: 1" = 10'

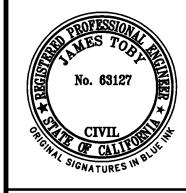PLN16-0067 EXHIBIT II June 15, 2017



• LAND SURVEYORS

SACRAMENTO REGION
3017 DOUGLAS BLVD, # 300
ROSEVILLE, CA 95661
(P) (916)966-1338
(F) (916)797-7363
ZE.COM

CIVIL ENGINEERS · LAND SI
REA REGION
NDUSTRIAL PKWY WEST
RD, CALIFORNIA 94545
ROSEVILLE, C
3017 DOUGLAS
(RD, CALIFORNIA 94545
ROSEVILLE, C
310) 887-4086
(P) (916)966

| Max Area Region 2495 Industrial PKWY West 2495 Industrial PKWY West HAYWARD, CALIFORNIA 94545 (P) (510) 887—4086 (F) (510) 887—3019 (F) (510) 887—3019

SAN LEANDRO TECH CAI RESIDENTIAL – TOI SAN LEANDRO, CALIFOF

SITE SECTIONS

JOB NO: 2151095

DATE: 04-25-17

SCALE: AS NOTED

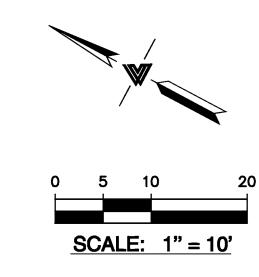
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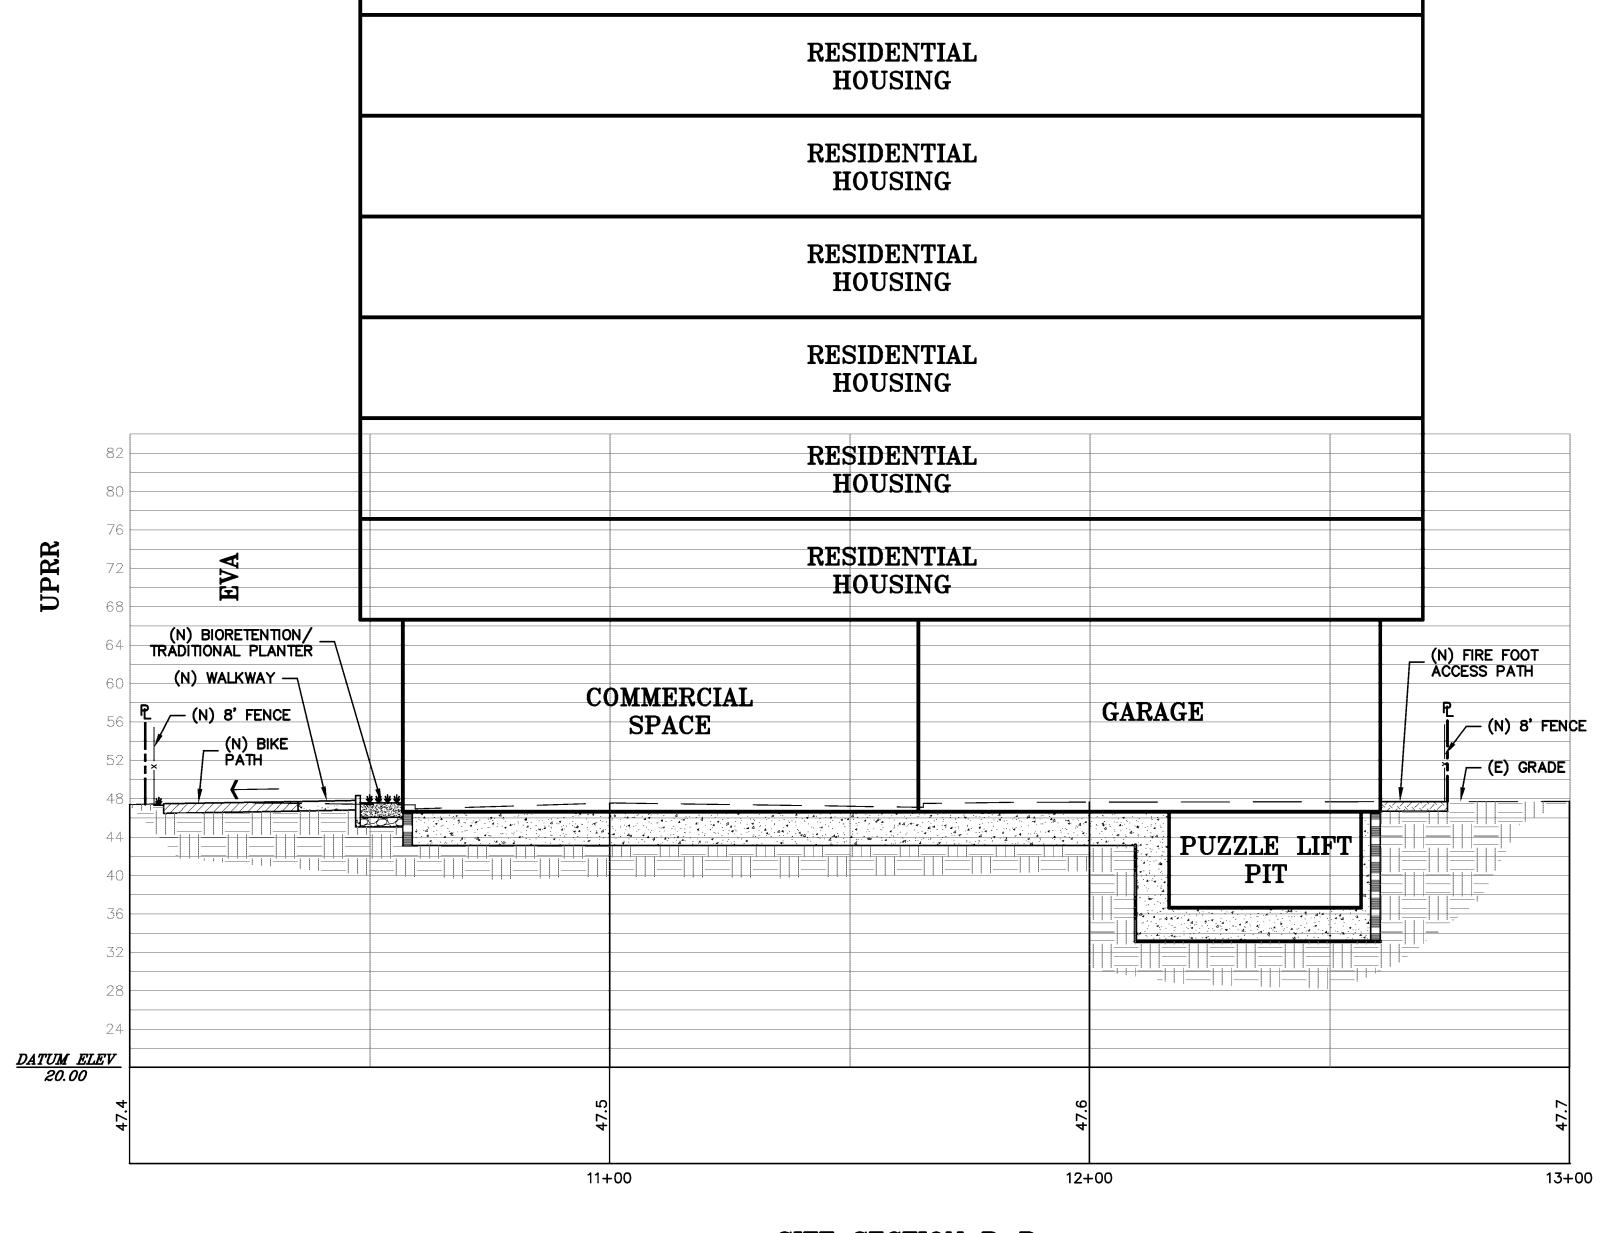
DESIGN BY: CP/MG

DRAWN BY: MG

SHEET NO:







SITE SECTION B-B HORIZ. & VERT. SCALE: 1" = 10'

> PLN16-0067 **EXHIBIT JJ** June 15, 2017



CH CAMPUS
- TOD

TECH SAN

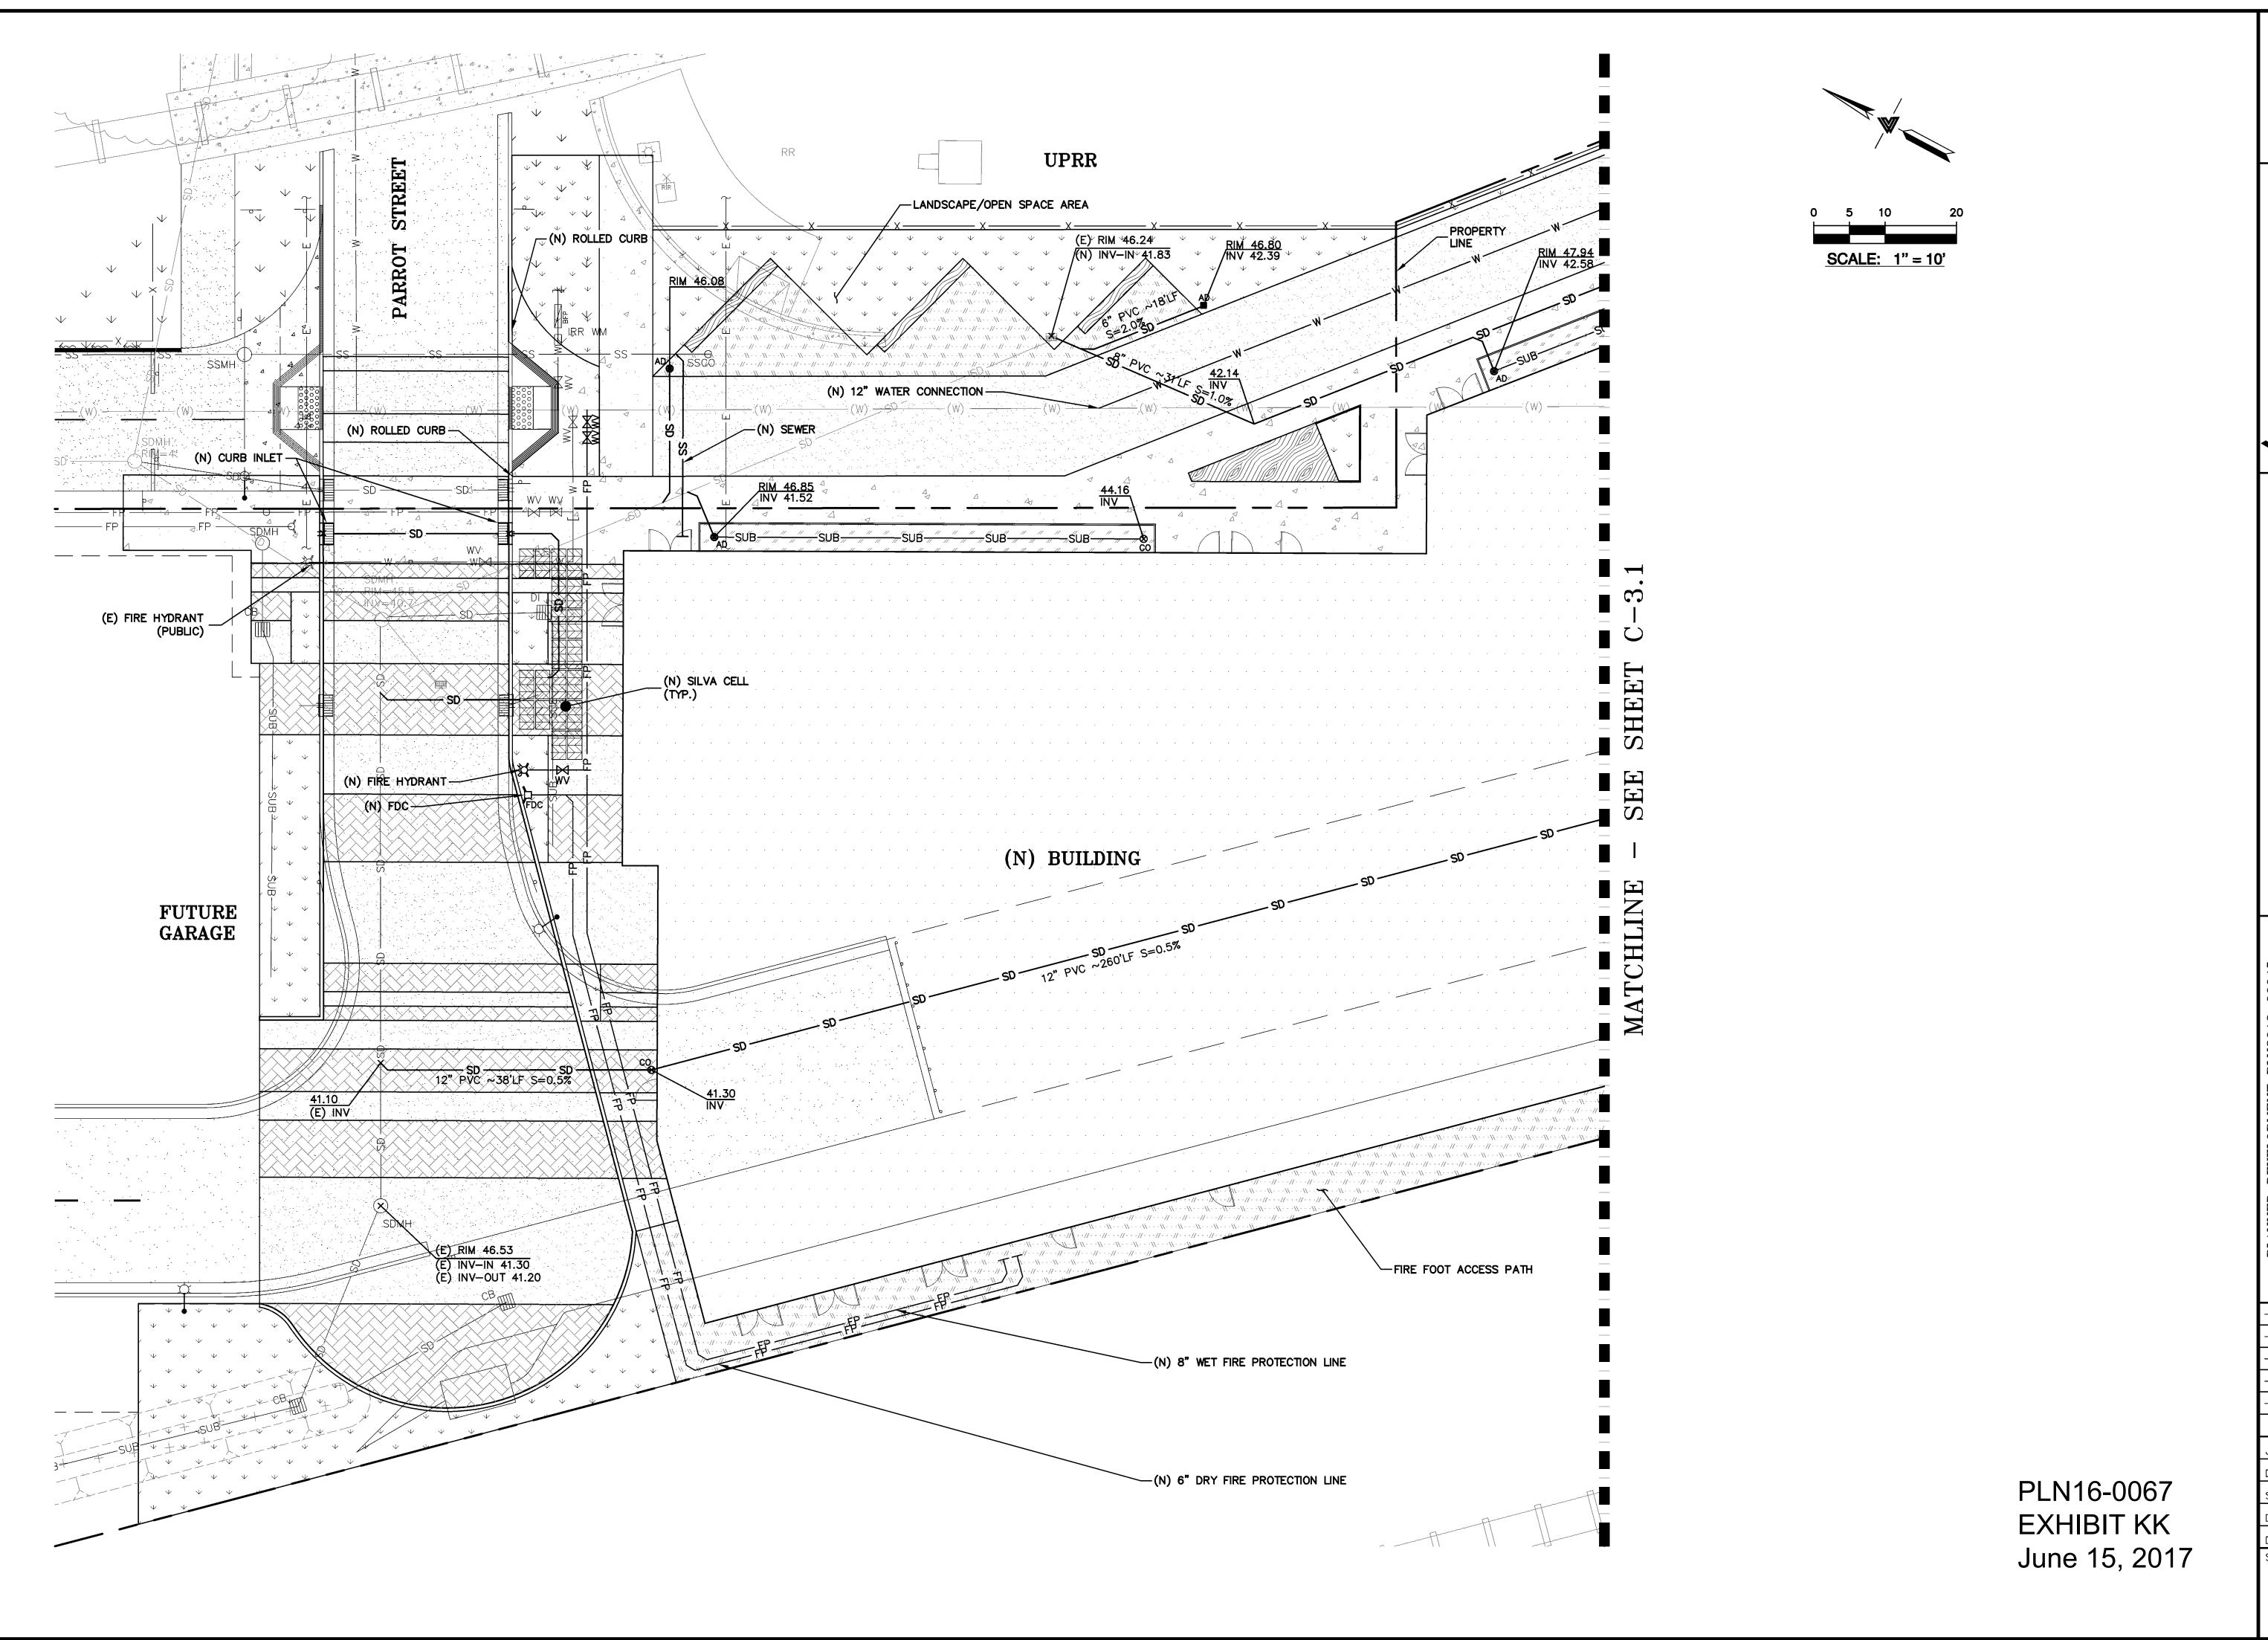
> SECTIONS SITE

REVISIONS

JOB NO: 2151095 DATE: 04-25-17 SCALE: AS NOTED

DESIGN BY: CP/MG DRAWN BY: MG SHEET NO:











REVISIONS JOB NO: 2151095 DATE: 04-25-1


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RUNOFF DRAINAGE DIRECTION

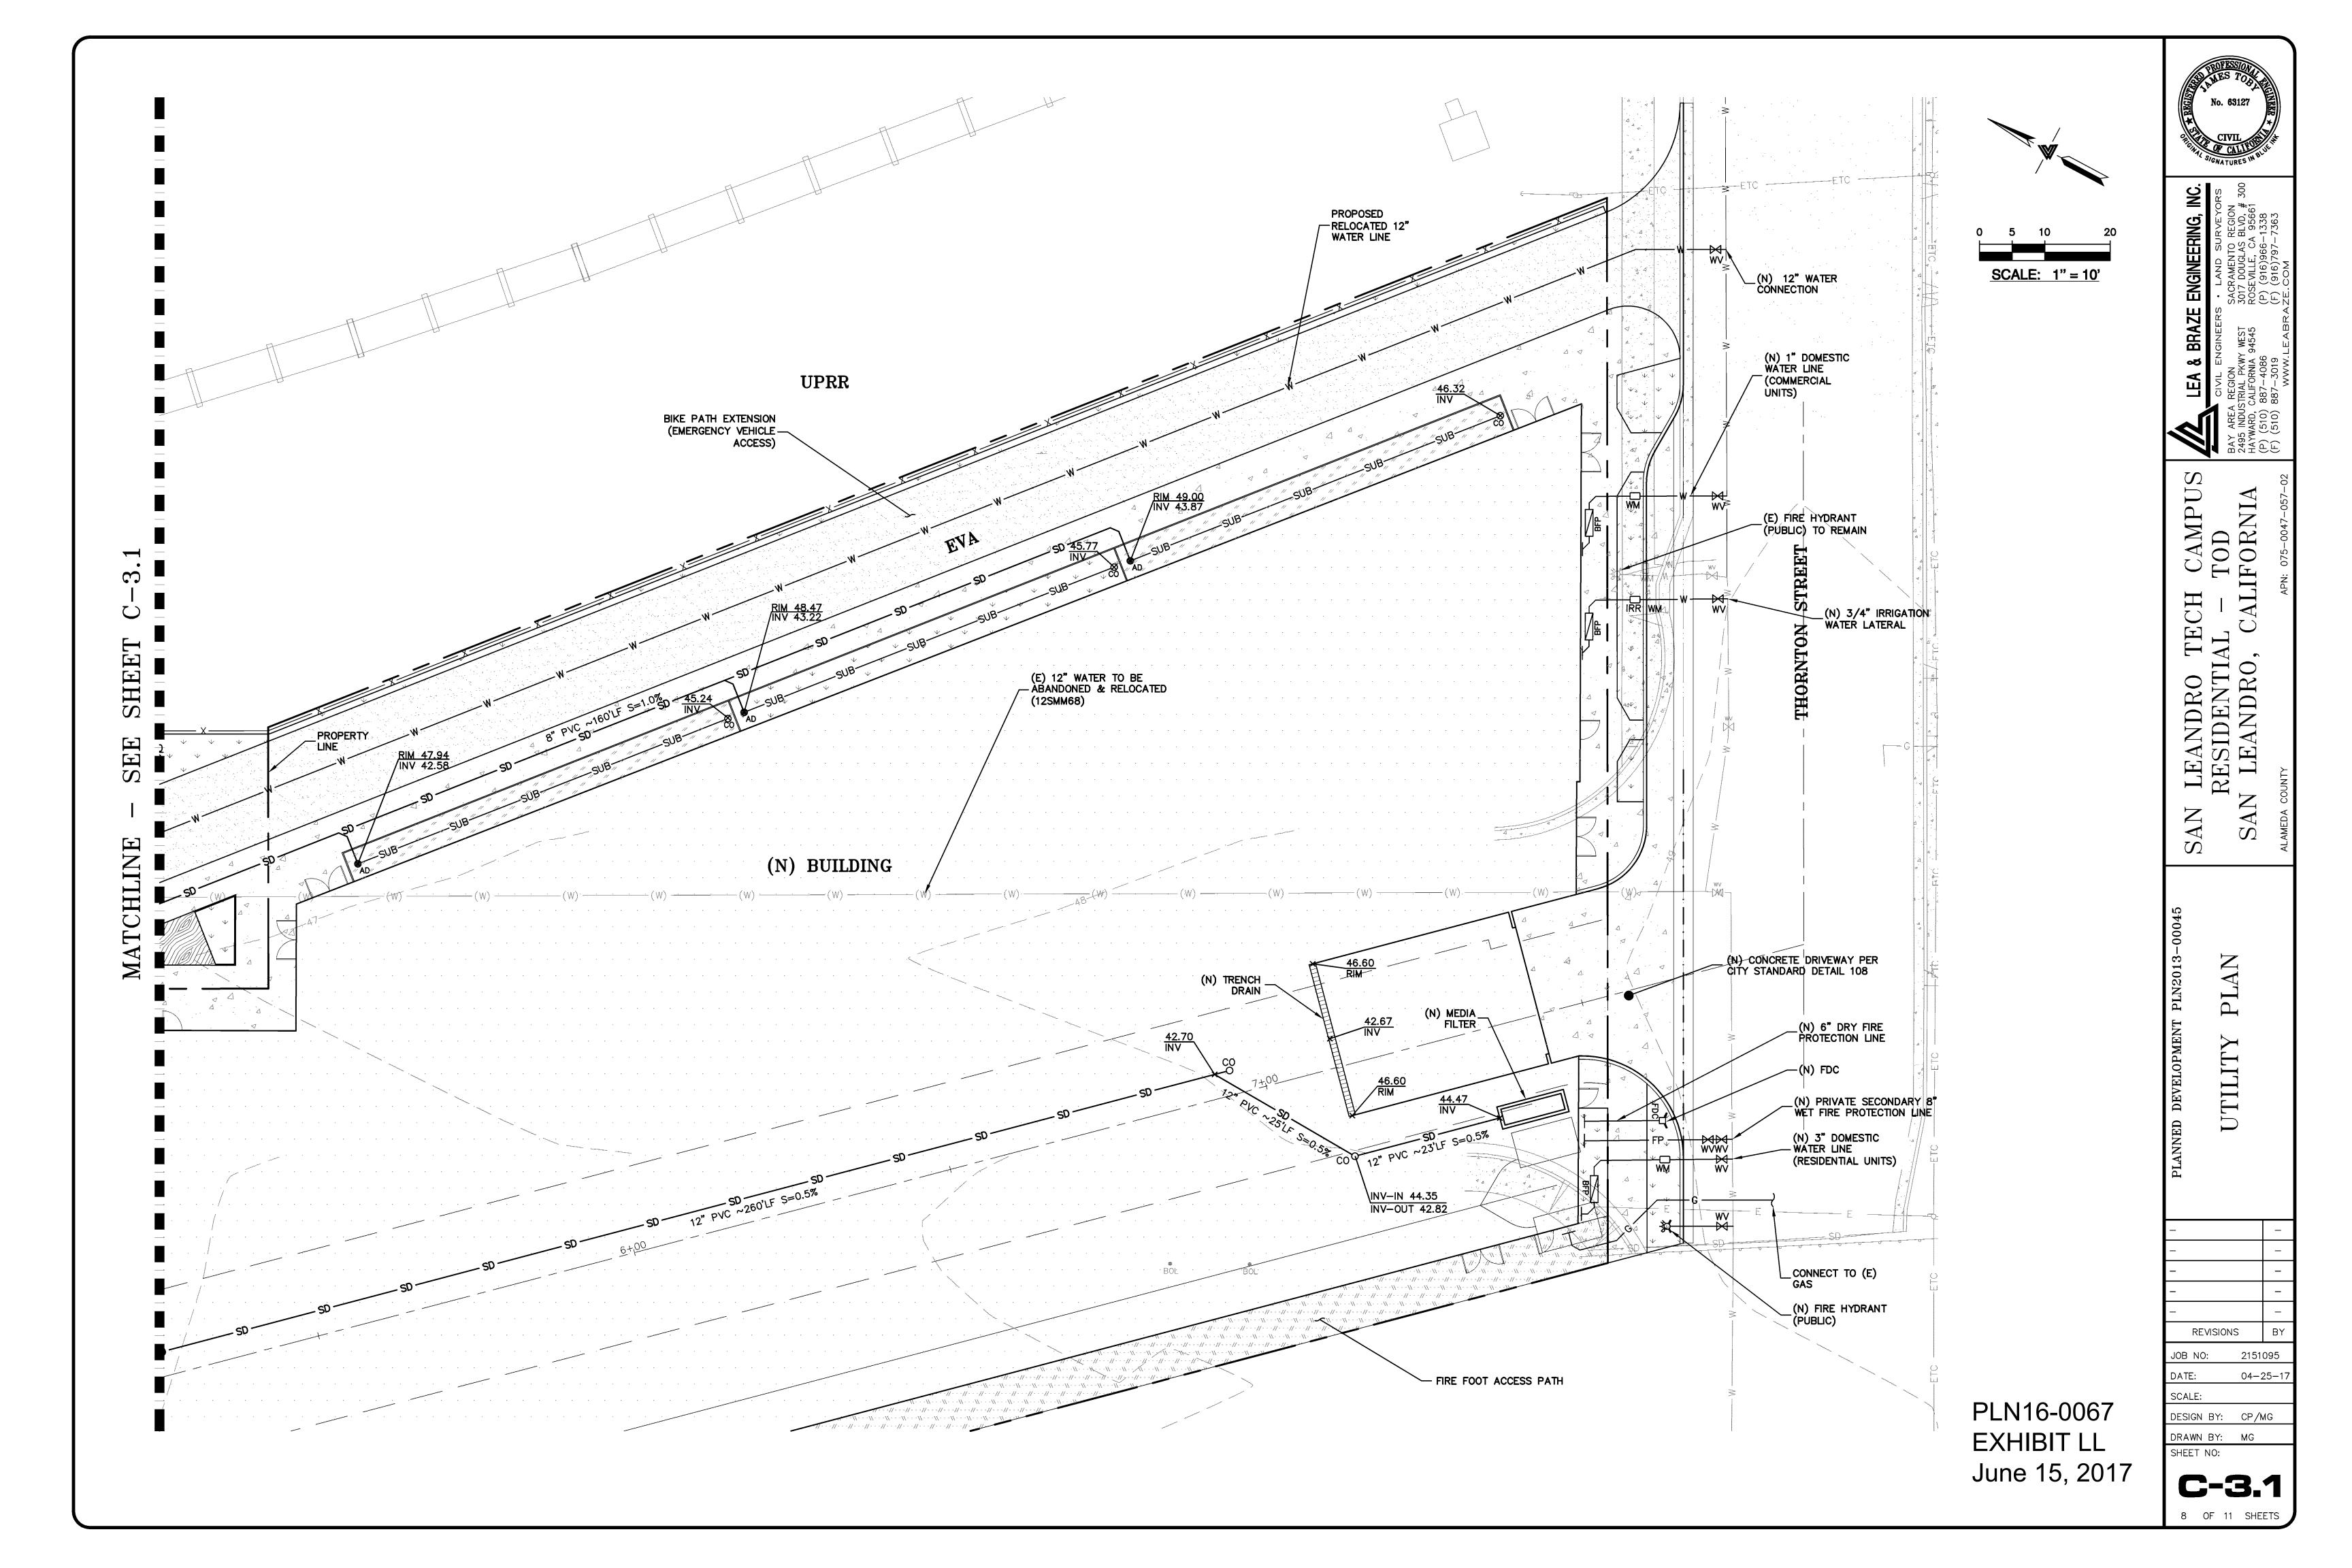AREA DRAIN

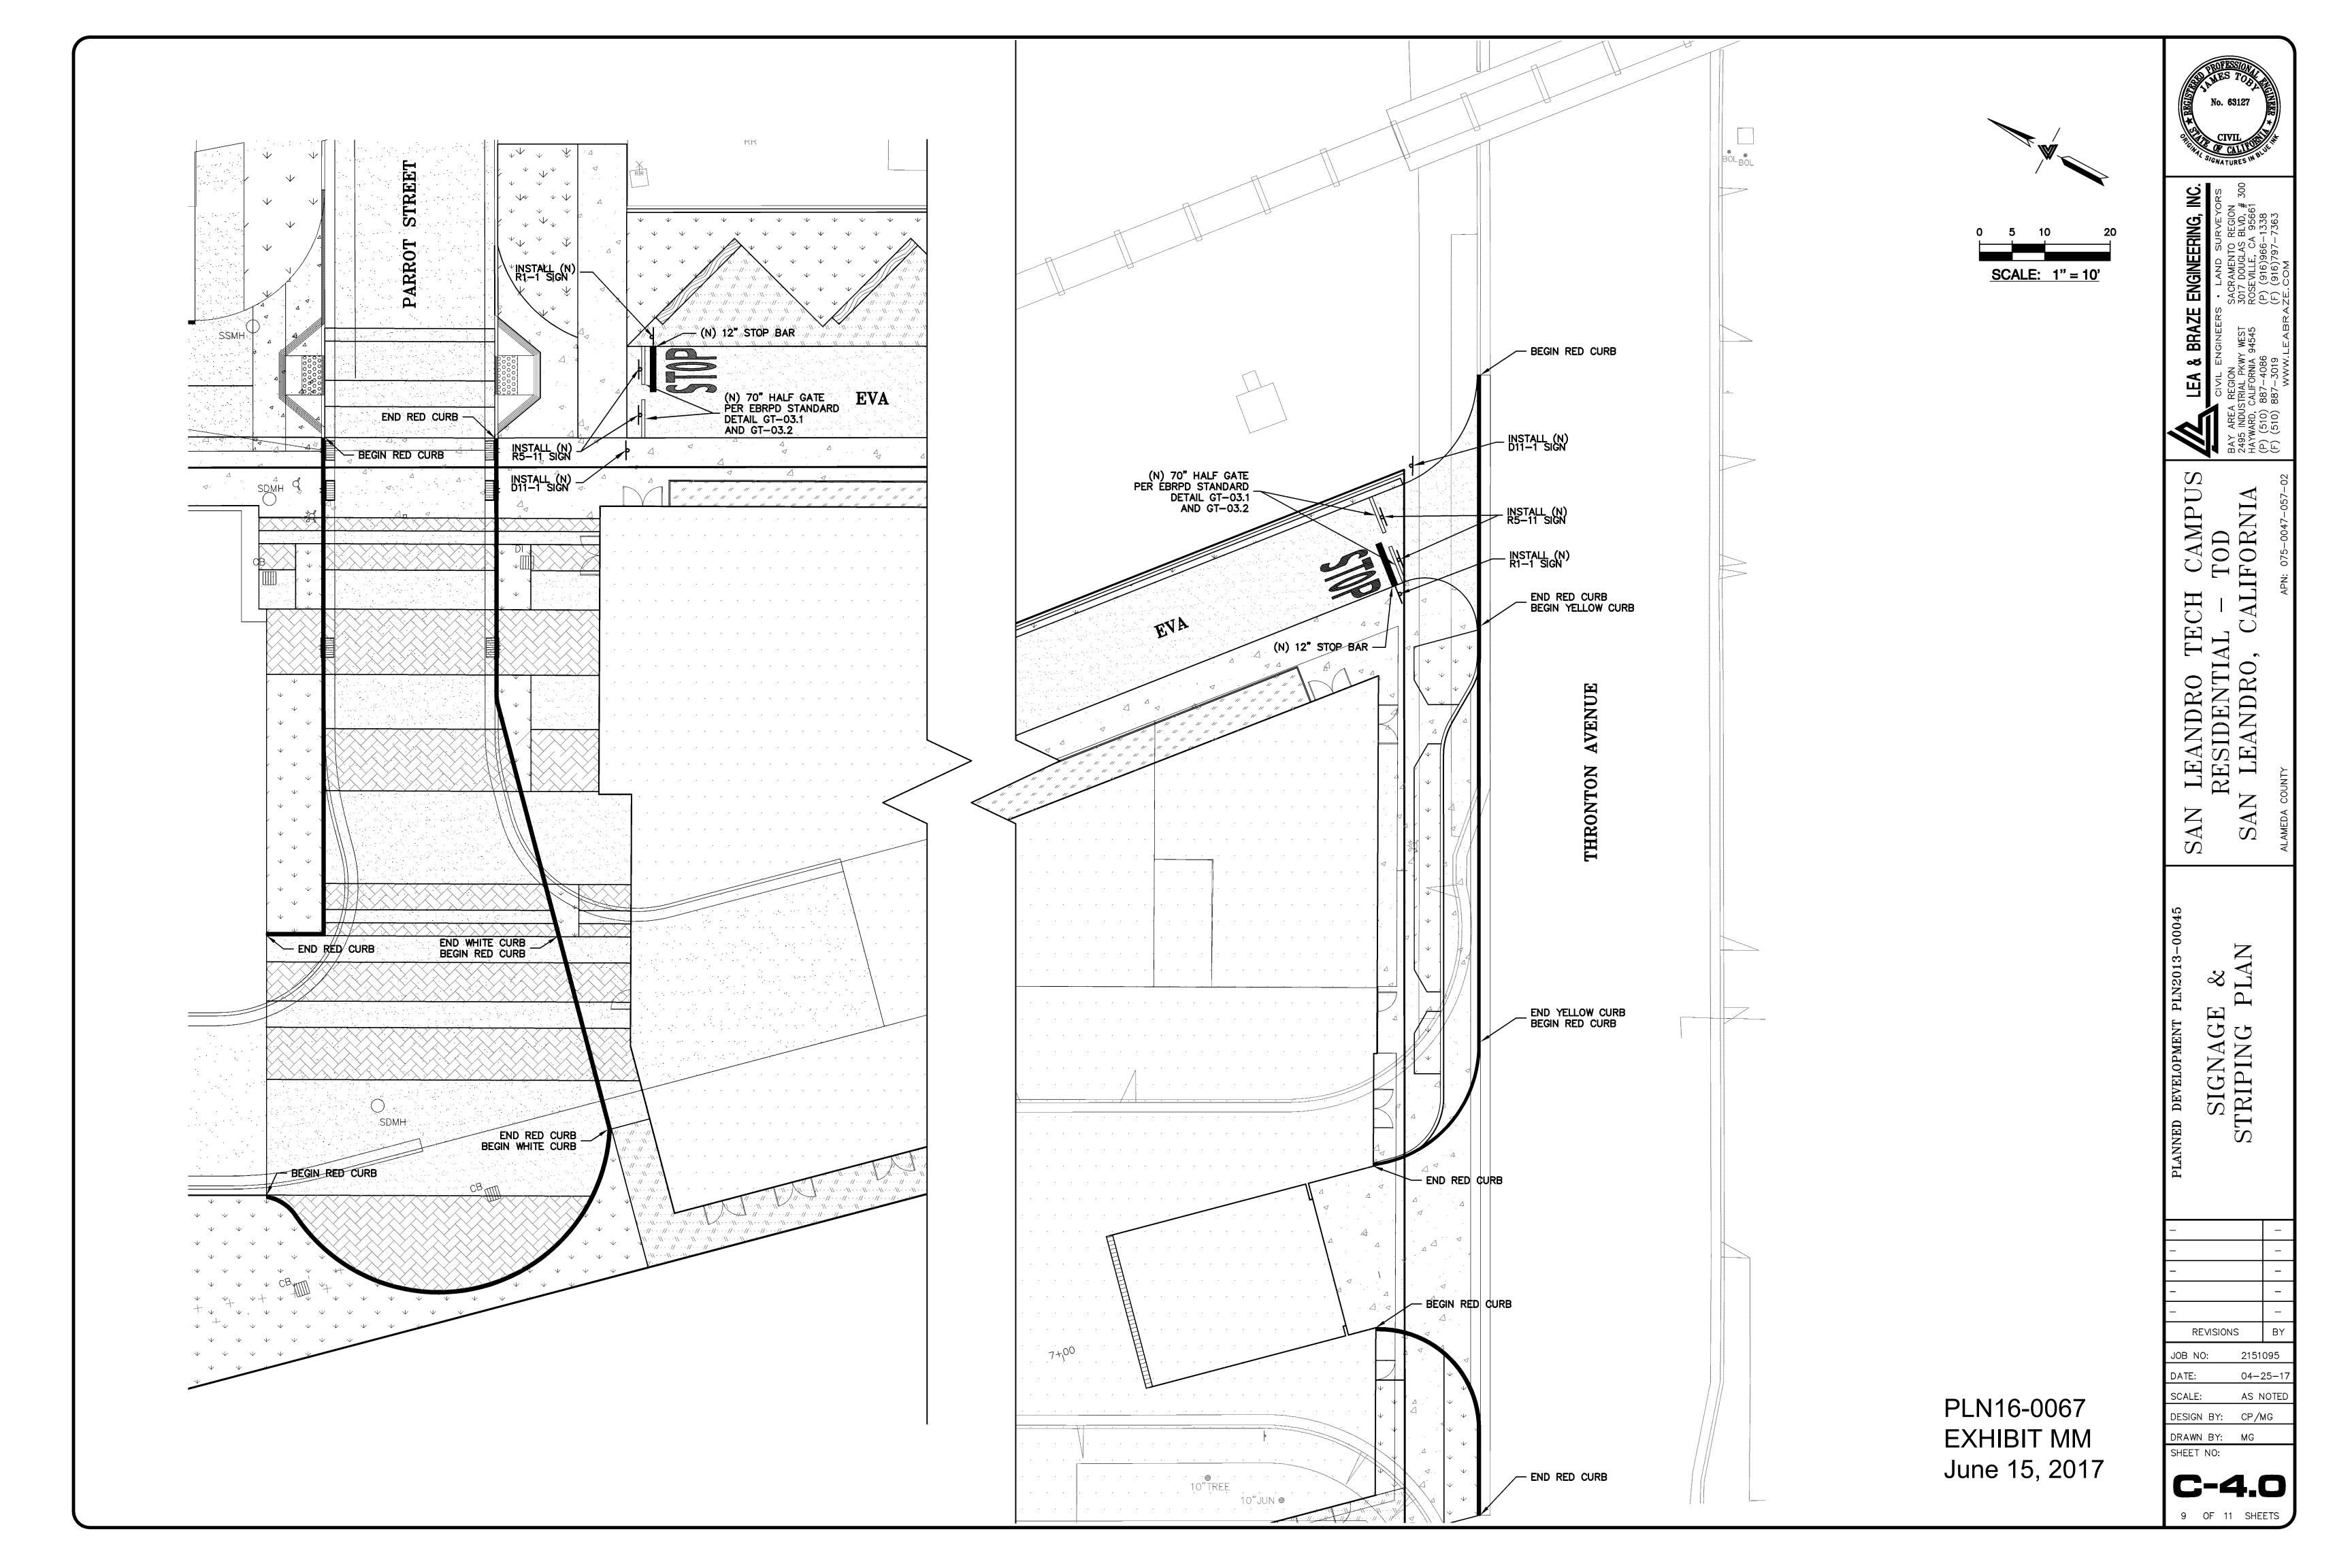DRAINAGE MANAGEMENT AREA

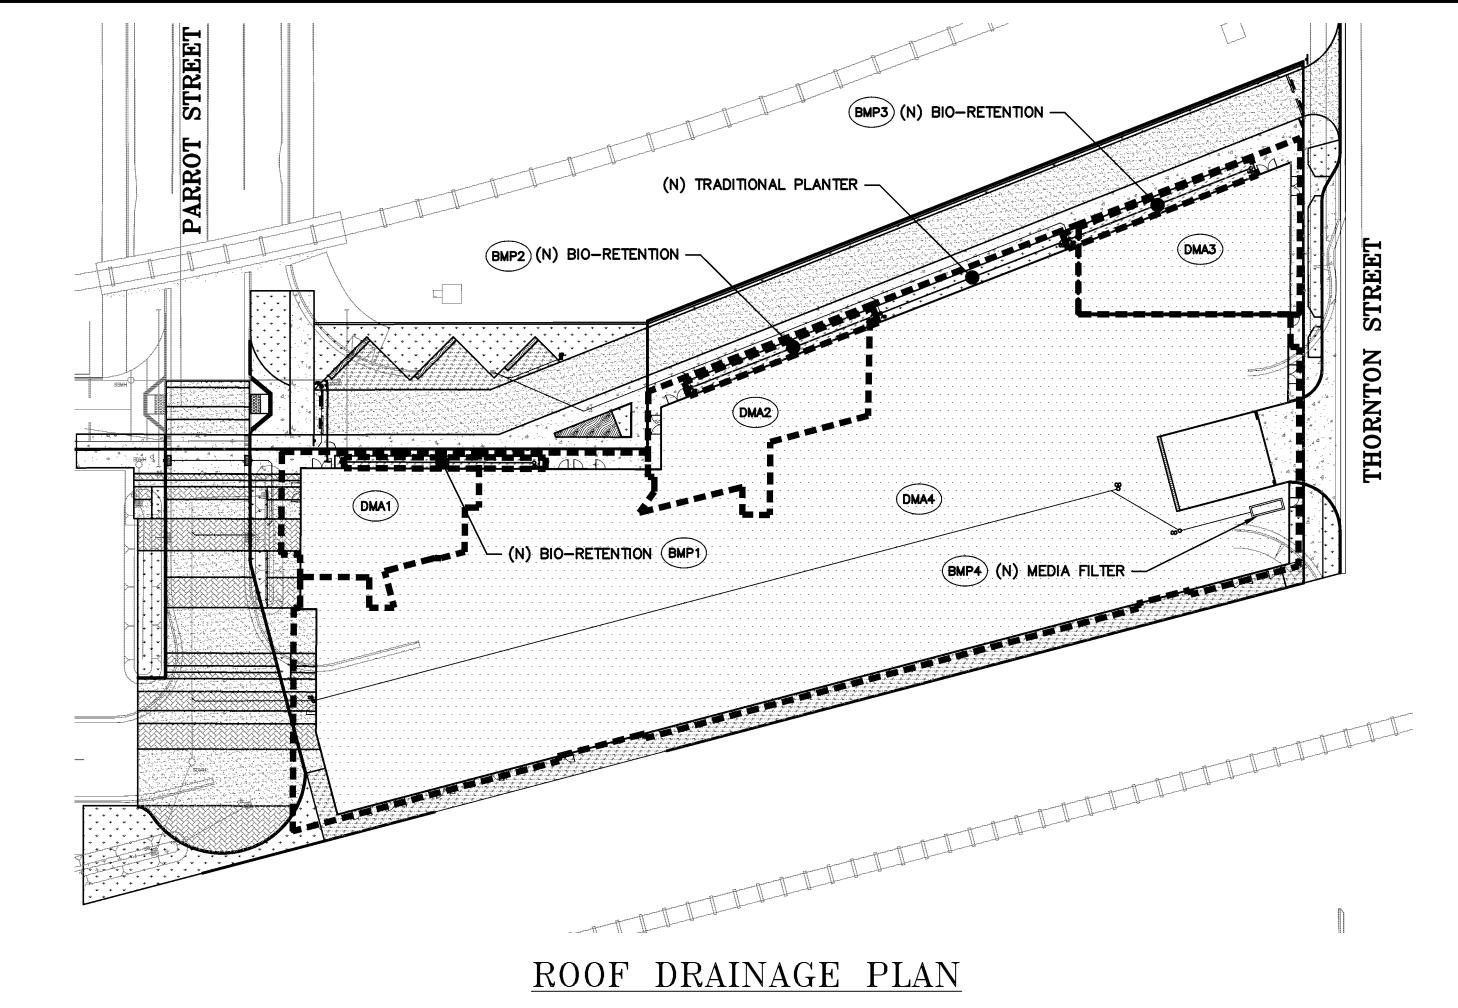BIO-RETENTION AREA

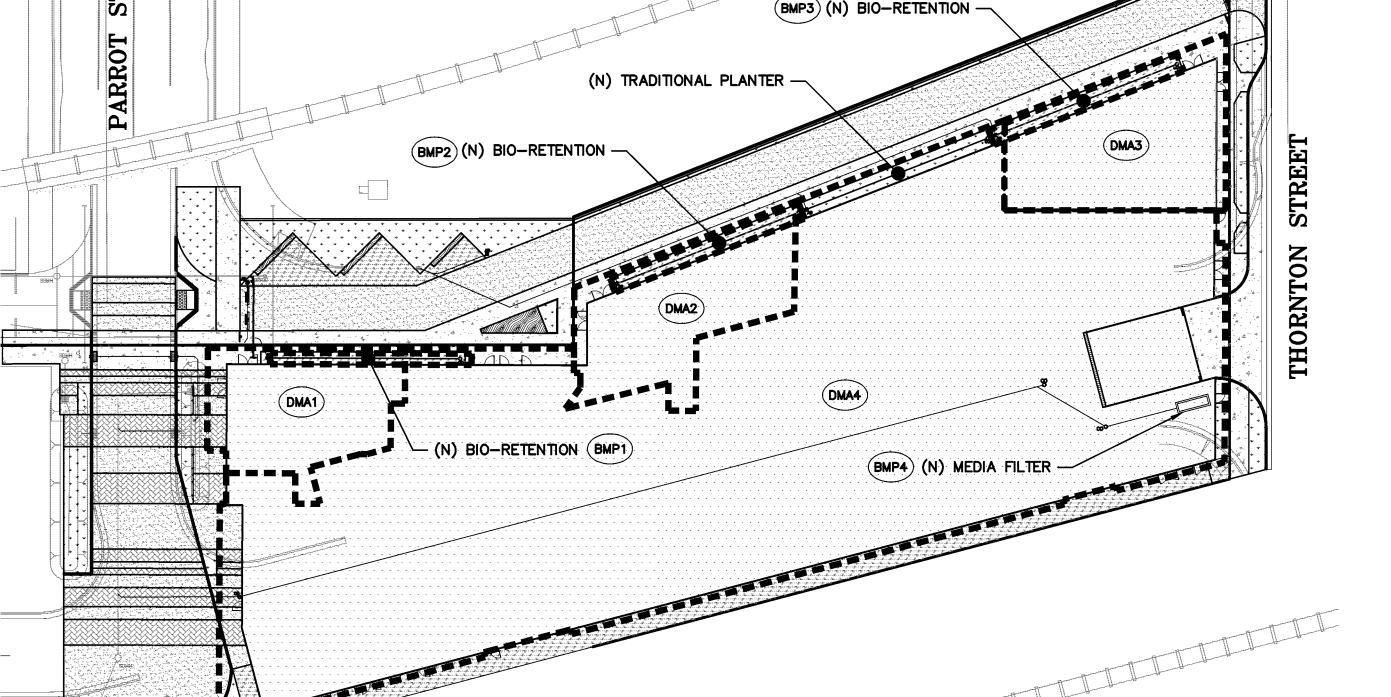LANDSCAPING AREA/ TRADITIONAL PLANTER

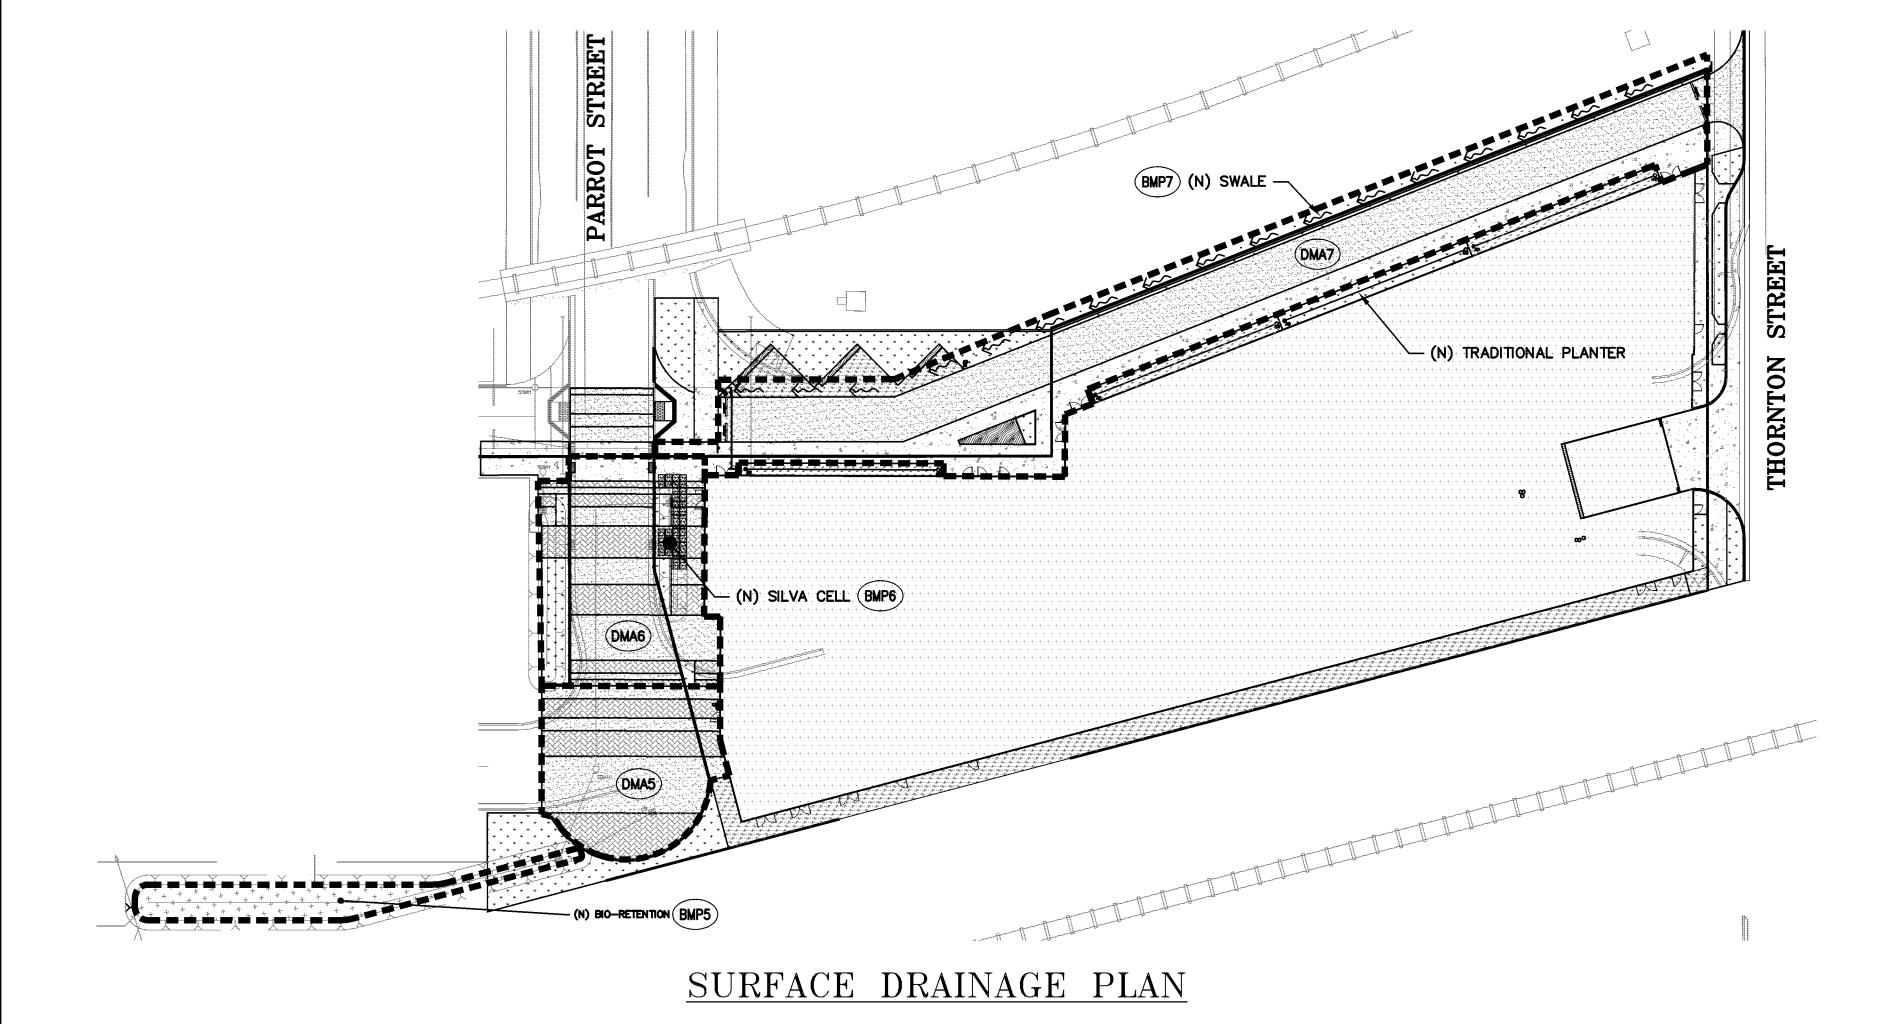

Sizing Volume Based Treatment Mesures based on the Adapted CASQA Stormwater BMP Handbook Approach

Calculations based on SCVRUPP C.3 Handbook Appendix B Section II.B dated April 2012

PROPERTY OWNER(S)	San Leandro Tech Campus - TOD		
PROPERTY ADDRESS	San Leandro, CA		
CALCULATED BY	M. Garcia	DATE	02/10/17
REFERENCE MAP:	2151095 HYD-1	JOB#	2151095

BLUE: User Input Value

SCALE: 1" = 30'

Drainage Management Area (DMA)	Treatment Control Measures (TCM)	Treatment Control Measures	Area Summary				
			New Impervious Area				
				Bio- Retention Area Required	Bio- Retention Area Provided	Available Treatment Areas > 4%	
			(SF)	(SF)	(SF)		
DMA 1	BMP 1	Bio-Retention	2,208	88	220	YES	
DMA 2	BMP 2	Bio-Retention	2,598	104	303	YES	
DMA 3	BMP 3	Bio-Retention	2,887	115	337	YES	
DMA 4	BMP 4	Media Filter*	28,397	-	-	N/A	
DMA 5	BMP 5	Bio-Retention	2,679	107	1,096	YES	
DMA 6	BMP 6	Silva Cell	3,731	149	180	YES	
DMA 7	BMP 7	Drainage Swale	9,493	-	-	N/A	

PROVIDED: FOUR ~27" CARTRIDGES AT 90 GPM TREATMENT CAPACITY

PLN16-0067 **EXHIBIT NN** June 15, 2017

NOTE:
FOR CONSTRUCTION STAKING
SCHEDULING OR QUOTATIONS
PLEASE CONTACT ALEX ABAYA
AT LEA & BRAZE ENGINEERING
(510)887-4086 EXT 116.
aabaya@leabraze.com



- TOD LIFORNI

TECH SAN

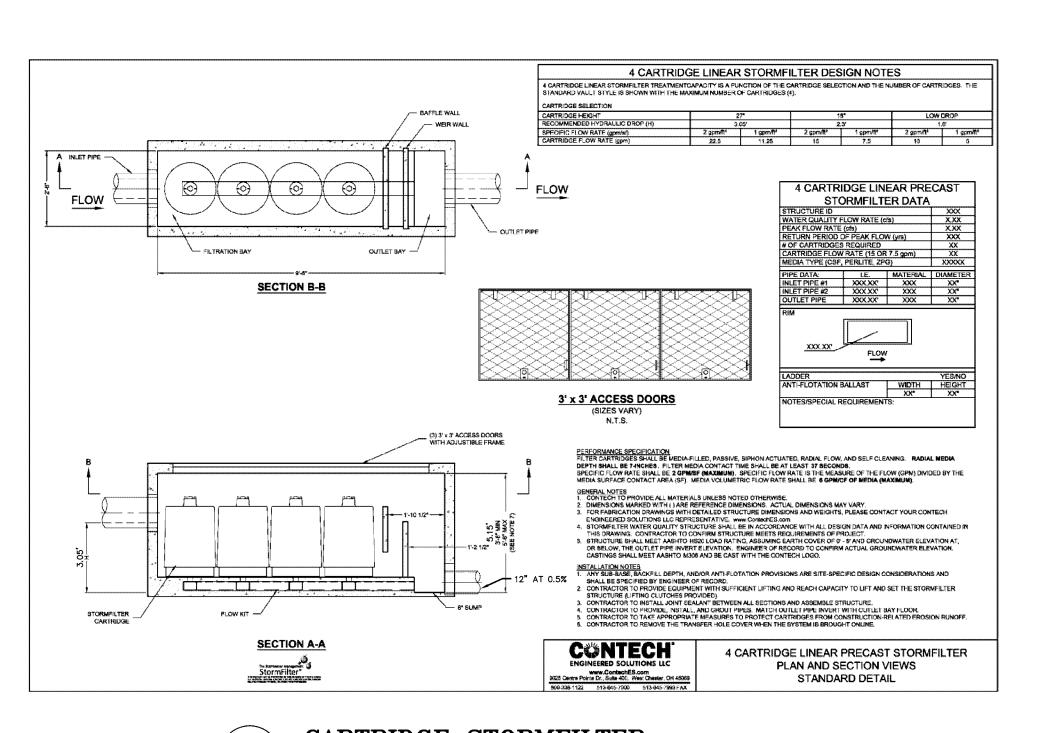
STORM WATER MANAGEMENT PL

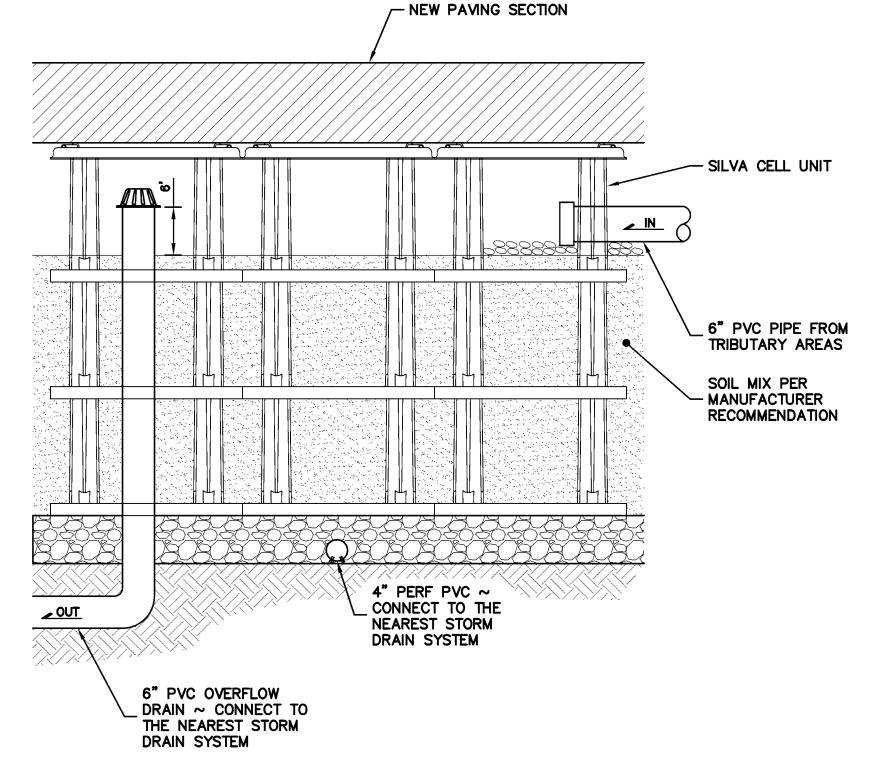
2151095

REVISIONS JOB NO: 04-25-17 SCALE: AS NOTED DESIGN BY: CP/MG

DRAWN BY: MG SHEET NO: HYD-1


10 OF 11 SHEETS





CARTRIDGE STORMFILTER

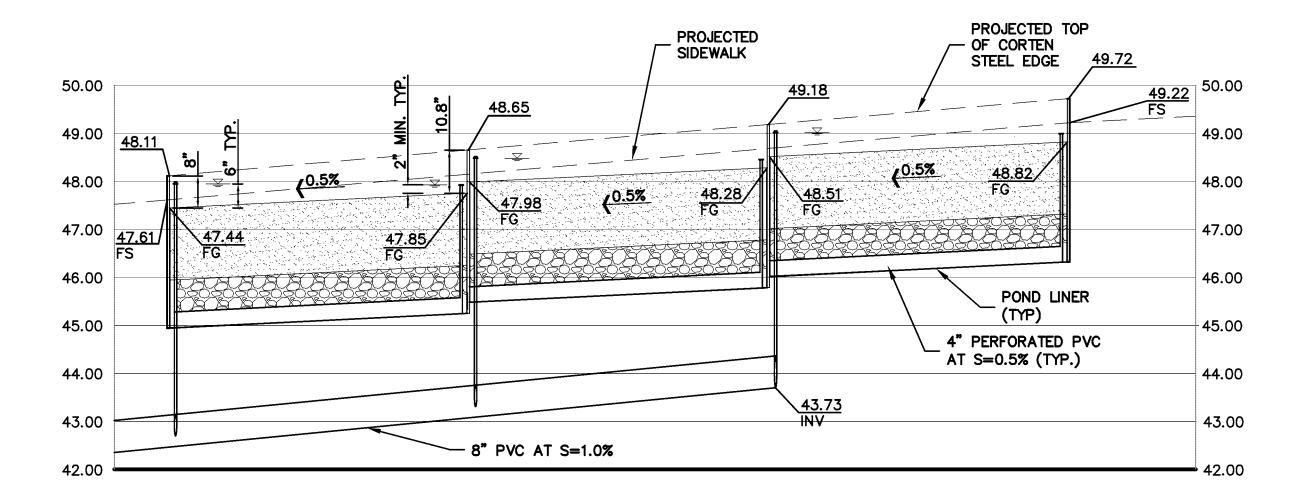TYPICAL SILVA CELL DETAIL NTS



FROM ROOF DRAIN -DOWNSPOUT / (N) BUILDING - 3"-6" RIVER ROCKS BIO-RETENTION SOIL MIX SHALL
BE PER ATTACHMENT L OF THE
ALAMEDA COUNTY C.3
STORMWATER GUIDANCE. CALTRANS CLASS II PERMEABLE MATERIALS

BIO-RETENTION PROFILE ALONG EVA SCALE: HORIZ. 1"=20' & VERT. 1"=2'

ROOF DRAIN DAYLIGHT HYD-2 NTS

> PLN16-0067 EXHIBIT OO June 15, 2017

AMPU\$ - TOD LIFOR

TECH SAN

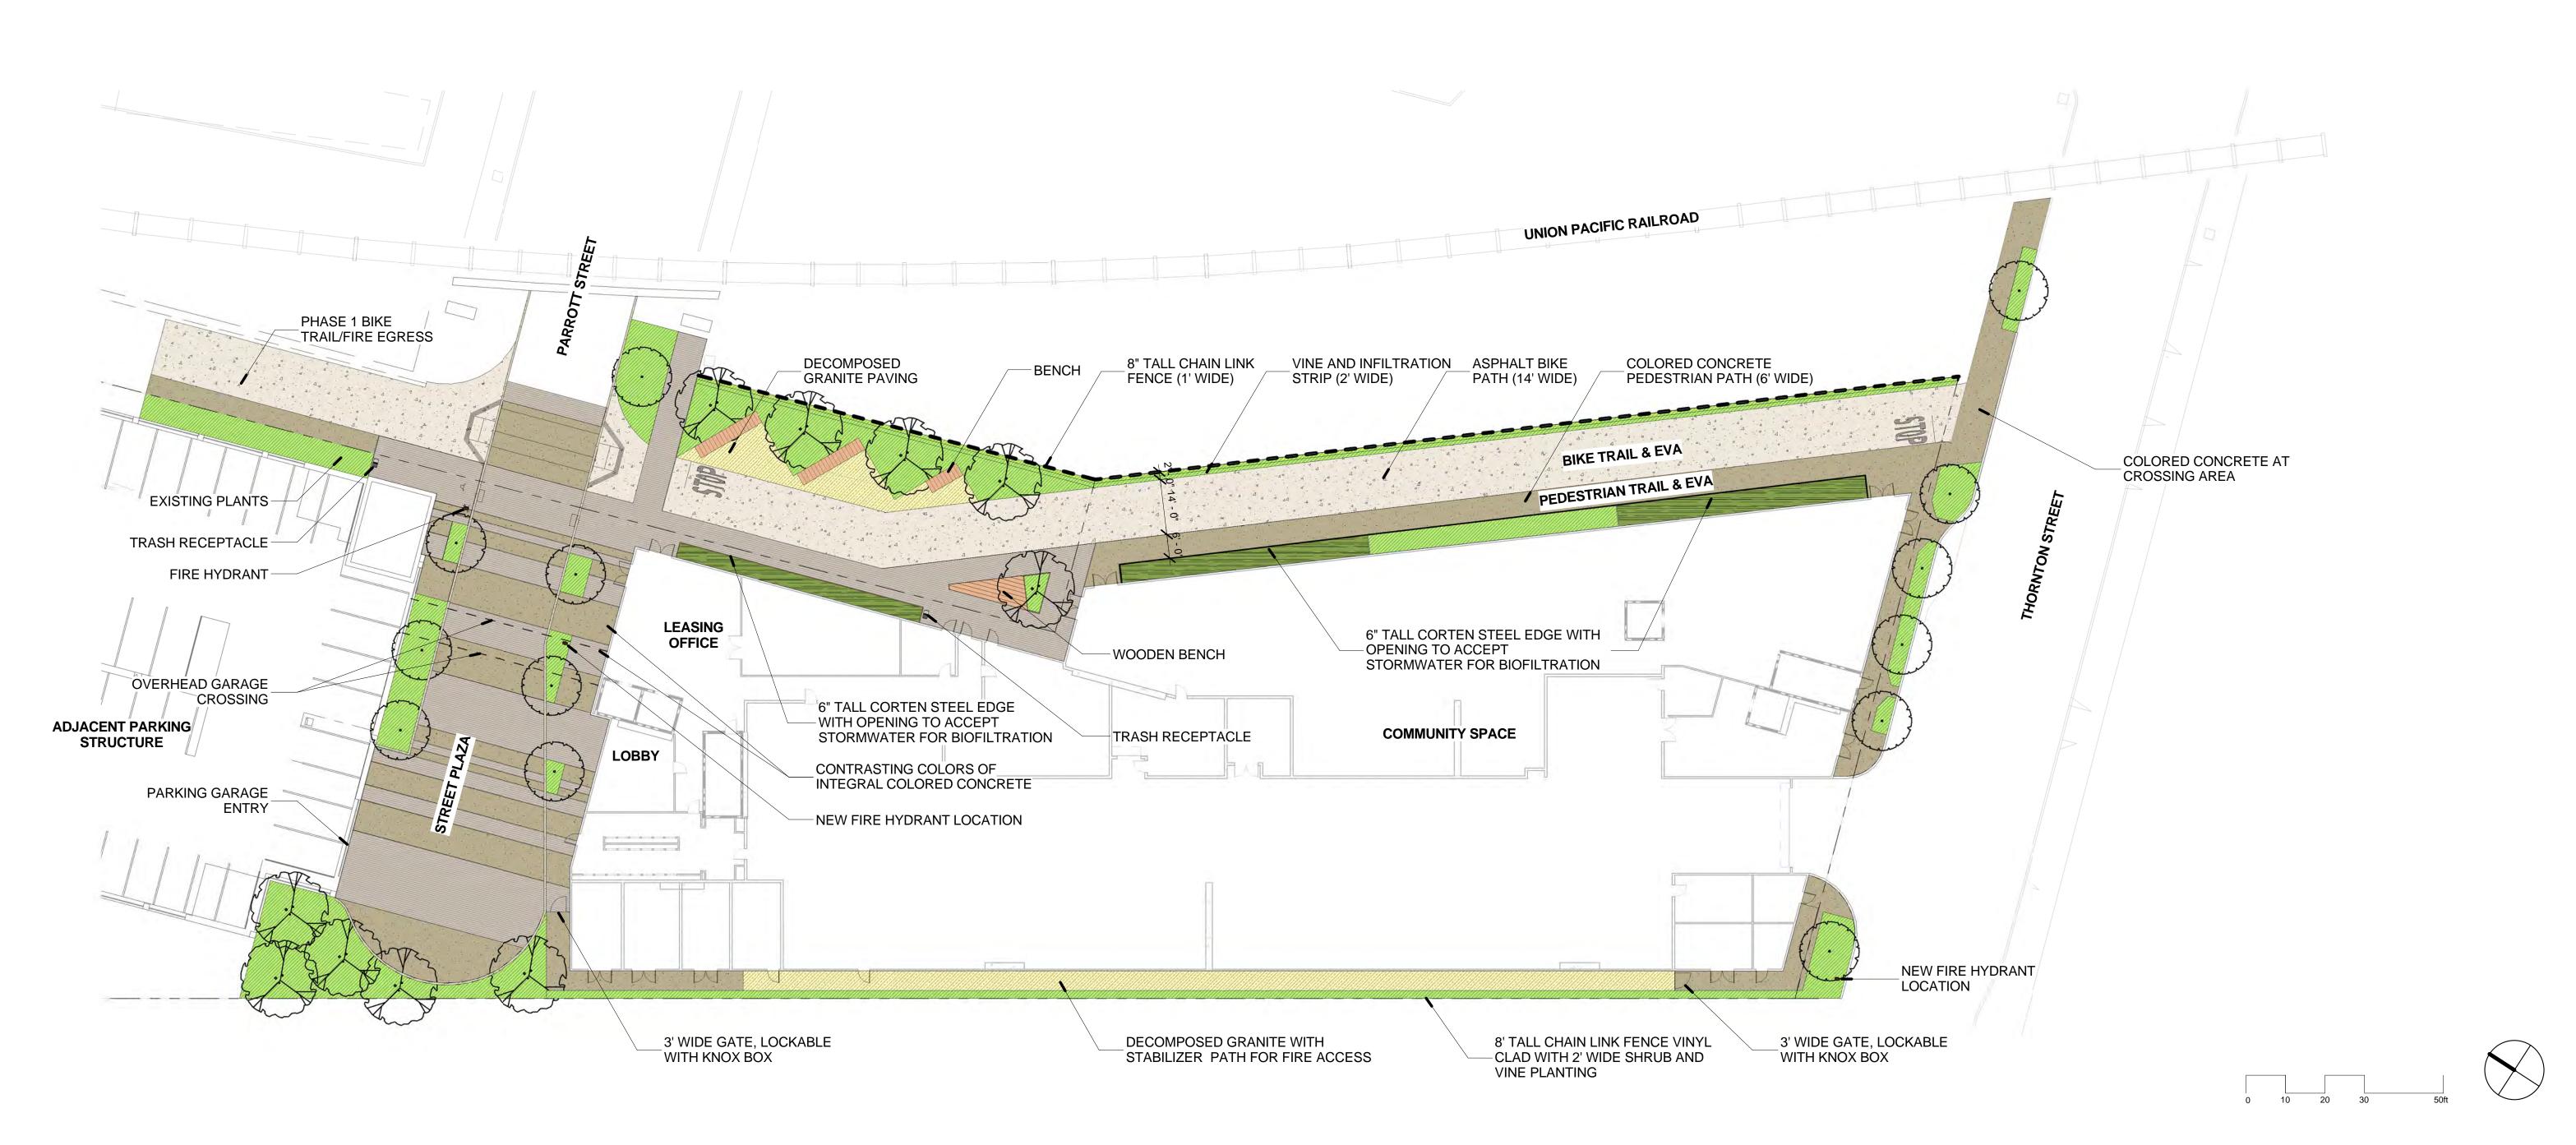
STORM WATER ANAGEMENT PL

REVISIONS JOB NO: 2151095

04-25-1 DATE:

SCALE: AS NOTED DESIGN BY: CP/MG DRAWN BY: MG SHEET NO:

HYD-2 11 OF 11 SHEETS



STREET LEVEL LANDSCAPE ELEMENTS



PLANTING - UNDERSTORY



ENTRY PLAZA PAVING: TWO TONES OF COLORED CONCRETE



BENCH: PRE-CAST CONCRETE WITH IPE

WOOD SLAT TOP

PARROTT STREET TREE: ACER RUBRUM 'RED SUNSET' (RED MAPLE)

FENCE AT PERIMETER:

EDGES, 8' TALL VINYL

UPRR AND SPRR

CLAD CHAIN LINK





THORNTON STREET TREE: ACER RUBRUM 'RED SUNSET' (RED MAPLE)



ACCENT TREE: NYSSA SYLVATICA (TUPELO)





BIKE RACKS & TRASH RECEPTACLES



ASHPALT PAVING, SEE CIVIL DRAWING



COLORED CONCRETE, COLOR B







PLANT LEGEND







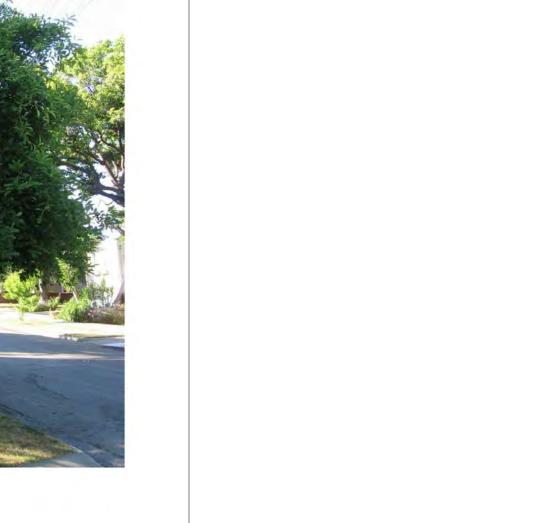
MWELO CONFORMANCE

SQUARE FOOTAGE OF LANDSCAPE: STREET LEVEL: 24,515 SF

LEVEL 2 COURTYARDS: 4,046 SF LEVEL 7 COURTYARD: 810 SF

THE PROJECT PLANTING AND IRRIGATION DESIGN WILL BE DESIGNED WITH LOW WATER USE PLANTS AND EFFICIENT IRRIGATION SYSTEM WHICH WILL MEET THE STATE'S MODEL WATER EFFICIENT LANDSCAPE ORDINANCE. COMPLETED CALCULATIONS AND WORKSHEETS WILL BE PROVIDED DURING BUILDING PERMIT PHASE.

PLANTS SELECTED WILL BE LOW WATER USE AND IRRIGATION WILL CONSIST OF SUBSURFACE DRIP WITH A SMART IRRIGATION CONTROLLER.



PLN16-0067 EXHIBIT PP June 15, 2017

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Project Number

As indicated Project Status

Proposed Modification

APRIL 26, 2017



ON-STRUCTURE MATERIAL AND PLANT LEGEND CONCRETE PAVER SYSTEM, TYPE A CONCRETE PAVER SYSTEM, TYPE B CAST IN PLACE CONCRETE WALL CORTEN STEEL WALL SHRUB AND GROUNDCOVER PLANTING

LOS ANGELES | IRVINE | OAKLAND


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LANDSCAPE ARCHITECTS

tel 510.465.1284 url PGAdesign.com 444 17th Street Oakland CA 94612

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NOT FOR



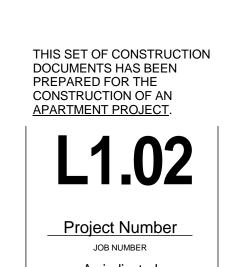Modification to Plant


PLN16-0067


EXHIBIT QQ

June 15, 2017

As indicated Project Status ISSUED AS APRIL 26, 2017

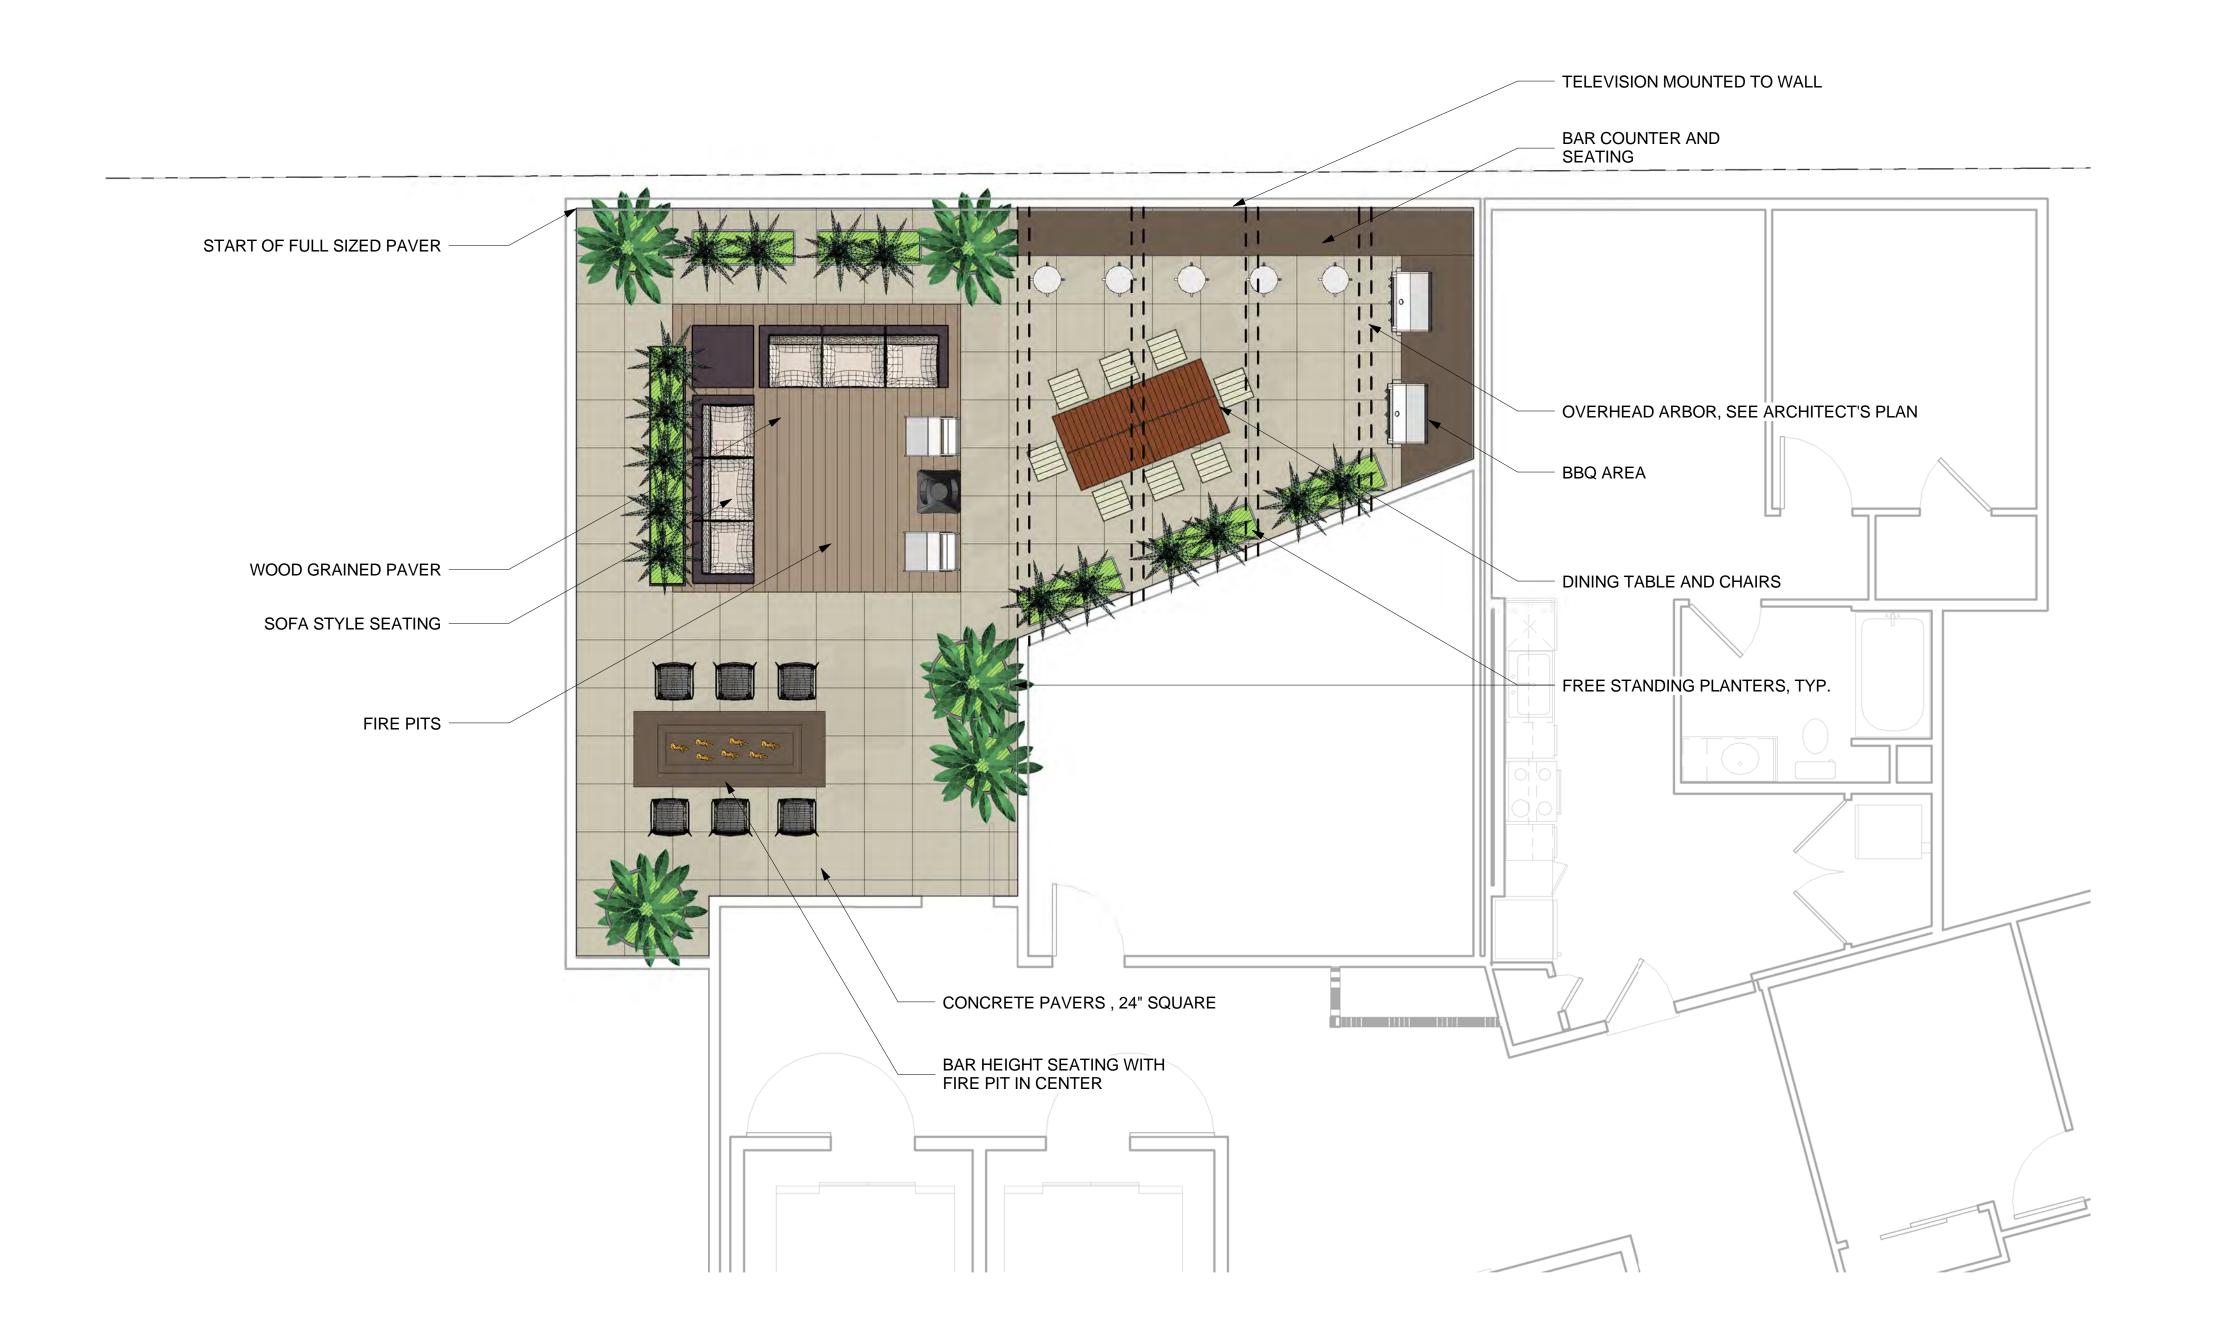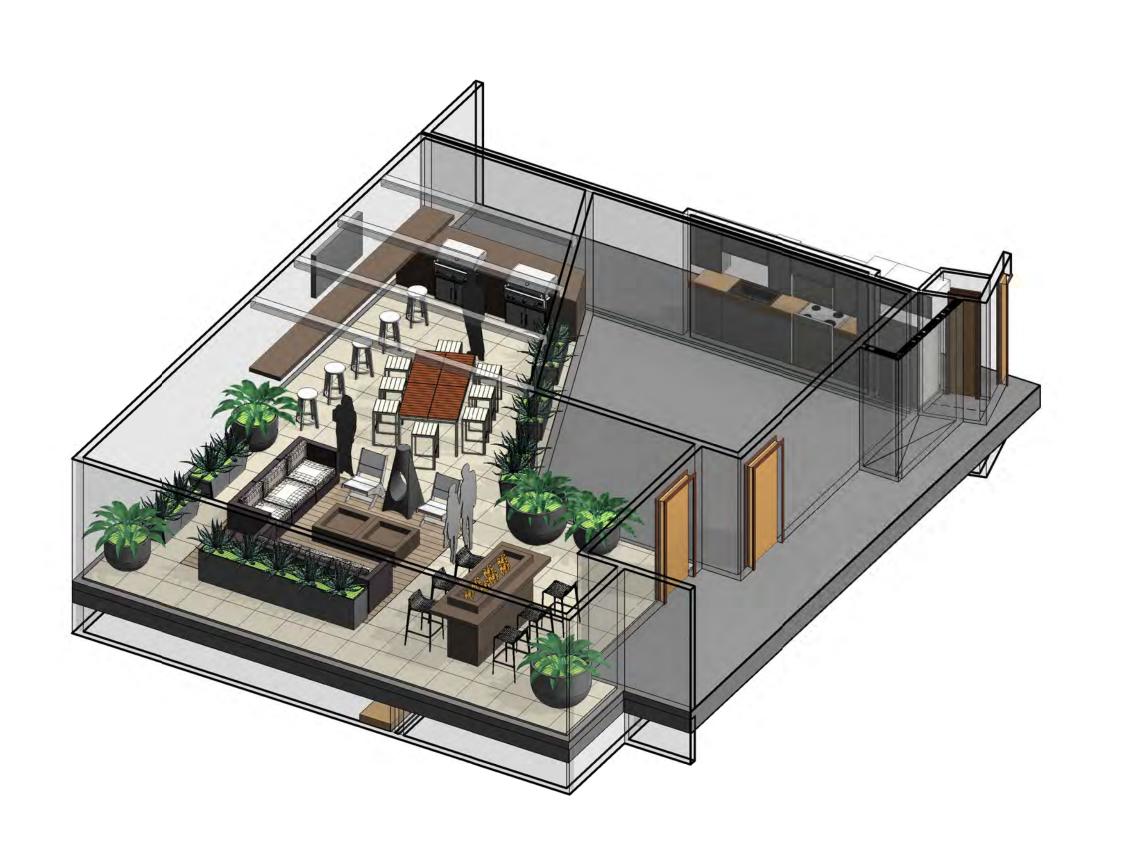LEVEL 7 COURTYARD





ON-STRUCTURE MATERIAL AND PLANT LEGEND

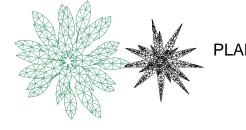
24" x 24" CONCRETE PAVERS



WOOD GRAINED PAVERS



SHRUB AND GROUNDCOVER PLANTING



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PLN2013-00045 dated February 20, 2014

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Project Number


1/4" = 1'-0"

Project Status
ISSUED AS

APRIL 26, 2017




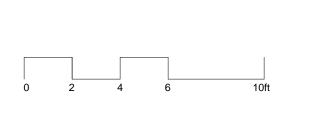PLN16-0067 **EXHIBIT RR** June 15, 2017





ON STRUCTURE PAVERS

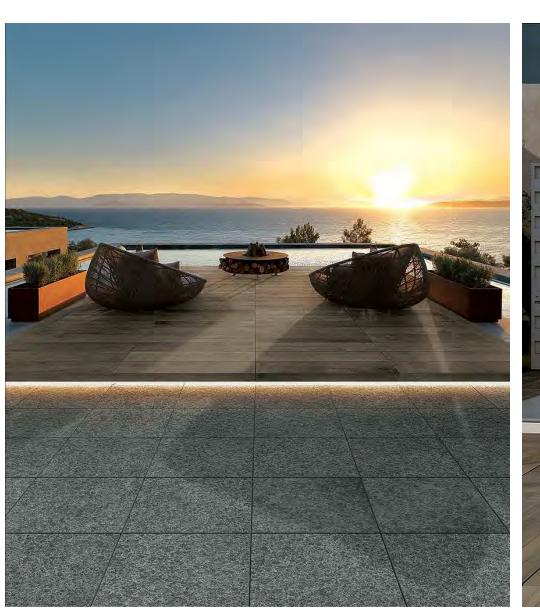



ON STRUCTURE FIRE PITS





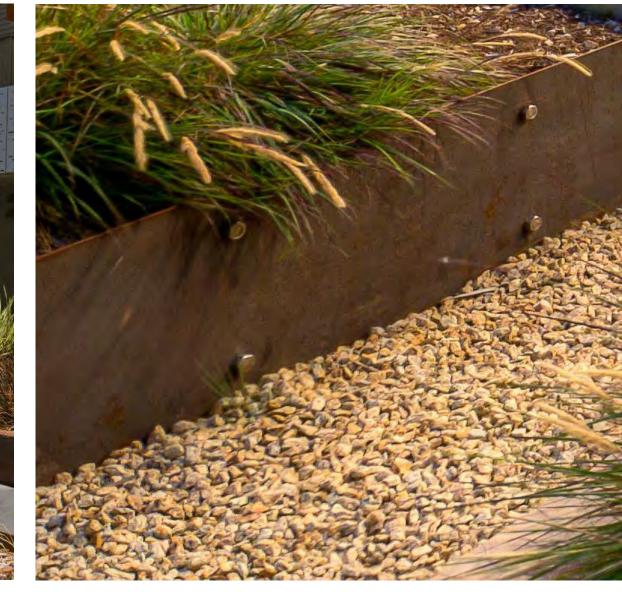


ON STRUCTURE PLANTERS



CORTEN STEEL WALL

SOFA SEATING









CORTEN STEEL WALL

CIP CONCRETE WALL

FREE STANDING PLANTER

FREE STANDING PLANTER

ON STRUCTURE SITE FURNISHINGS

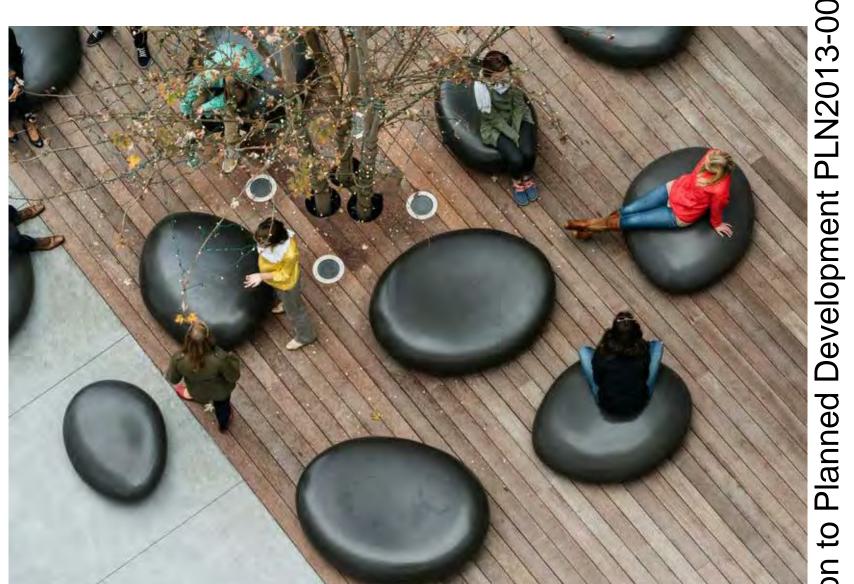




MOVABLE SEATS







MOVABLE SEATS

DINING TABLE

OVERSIZED PEBBLE SEATS



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DATE

AKI OU Pere rban

Enter address here Westlake Urbai

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L2.01

Project Number

JOB NUMBER

SCALE

Project Status
ISSUED AS

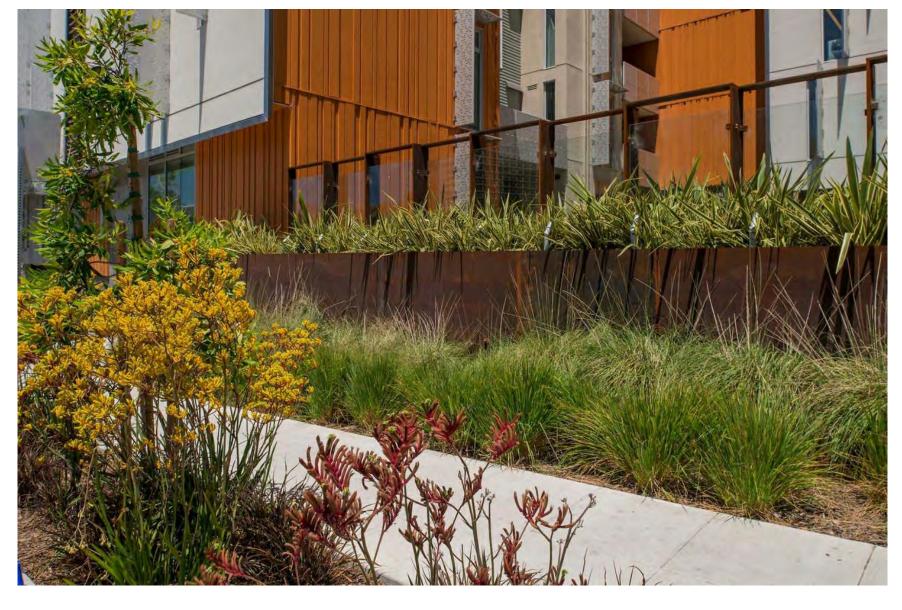
APRIL 26, 2017

ON STRUCTURE PLANT PALETTE





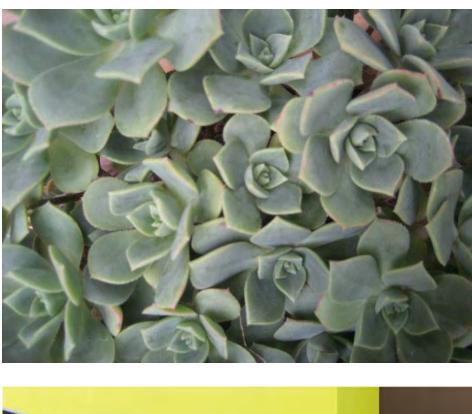
UNDERSTORY SHRUBS AND GROUNDCOVERS



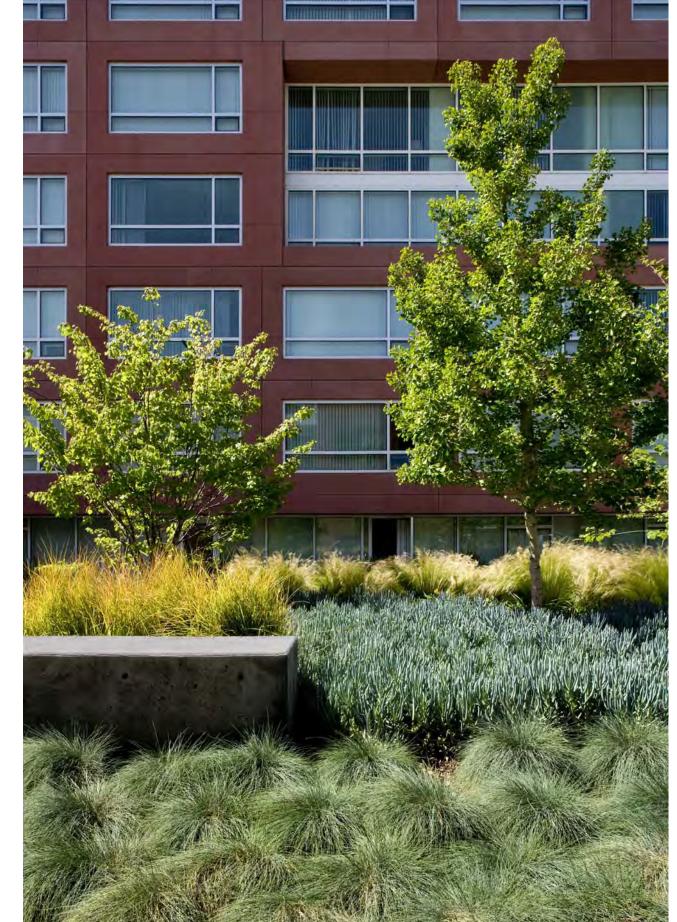






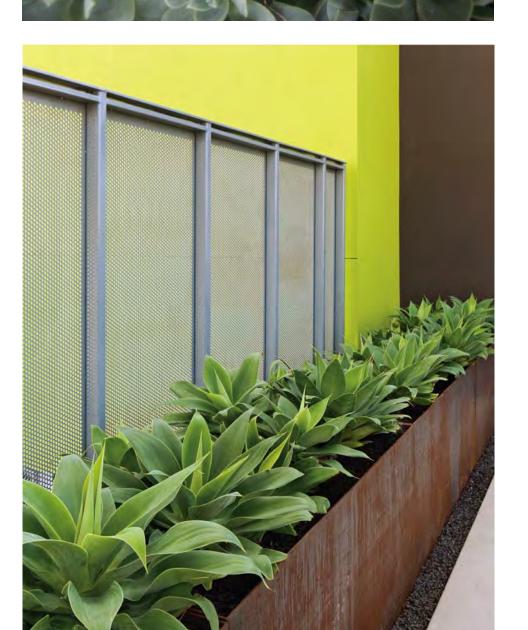


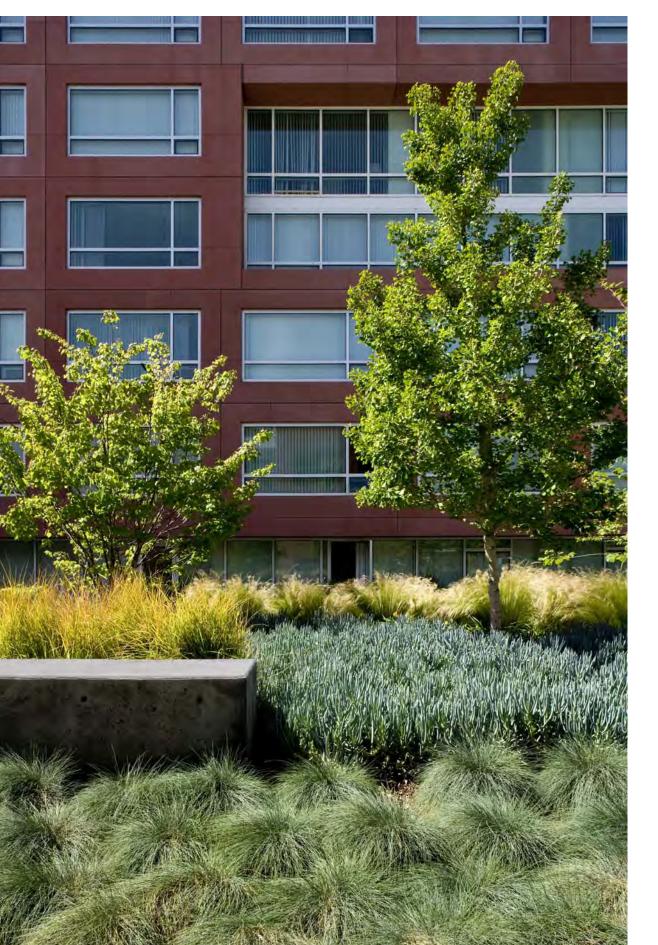












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APRIL 26, 2017
ISSUE DATE