


**High East Isometric** 



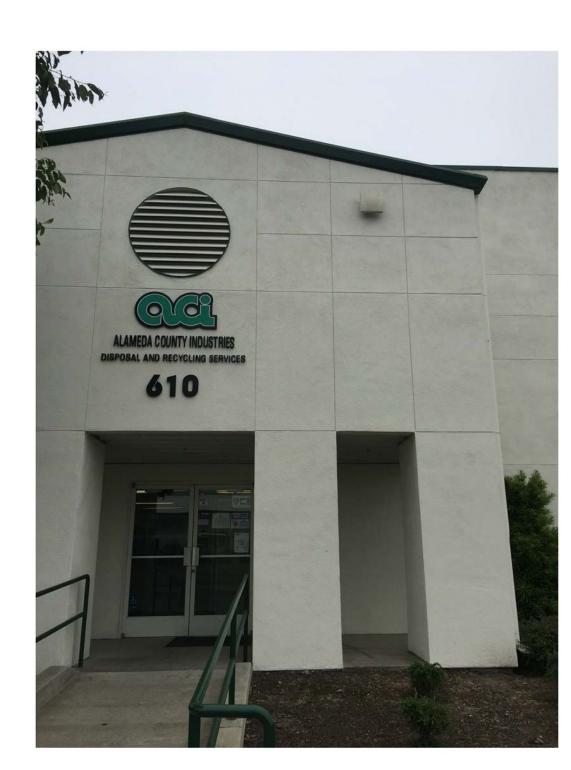

**Existing Facility Entrance** 

The proposed transfer station expansion will be constructed in the same style, with the same color scheme, as the photos shown.

# Review Comments (With Key to Drawing Revisions)

Alameda County Fire Department Review Comments
The fire department access road is shown as 20 feet wide. As the building is over 30 feet in height the fire department access road is required to meet the requirements of Sections D105.1 and D105.3 for aerial fire apparatus. Clearly show how access road complies.

### Fire Access Layout: See new sheet 1.3

hose stream allowance.

The water supply shall be capable of providing the greater of:

a. The automatic sprinkler system demand, including

b. The required fire-flow which is 1,500 gpm at 20psi for 2 hours.

# Fire Sprinkler and Fire Flow: See text at left edge of new sheet 1.3.

Building and Safety Services Division Review CommentsSquare footage shown on Building Area Calculations does not match Site Plan Square Footage. Please clarify.

Square Footage: See revised sheets 1.1 and 1.2. Revised plan square footage on site plans to agree with tabular data. Areas are conservatively measured for these calculations. Exact final areas will provided with permit submittal documents and are pending detailed survey of existing conditions.

2. Please verify that Vertical Continuity of Fire Wall meet the intent of the CBC Sec. 706.6.

Fire Wall Continuity: See new note on detail B of revised sheet B2 noting fire wall extends 36" above existing roof.

### Planning Services Division Review Comments

Please provide additional information on the following:
 a. Provide Lot Coverage calculation for 610 Aladdin Avenue

# Lot Coverage: see revised sheet 1.2 with new project data table

b. Provide Floor Area Ratio (F.A.R.) calculation for 610 Aladdin Avenue

# FAR: see revised sheet 1.2 with new project data table

c. Provide setback dimensions for the proposed transfer station addition building at 610 Aladdin Avenue in the plans and in a table.

Setback Dimensions: see revised sheet 1.2 with setback dimensions added and table of setbacks in top left corner of sheet.

d. Provide the proposed roof height for the top of proposed transfer station addition building on the elevations

## Roof Height: see revised sheet 3.0 with roof peak elevation

e. Provide a color rendering for the proposed transfer station addition building

Rendering: see revised cover sheet 0.1 with photographs of existing facility and statement that "The proposed transfer station expansion will be constructed in the same style, with the same color scheme, as the photos shown."

### Drawing List

- 0.1 Cover Sheet
- 0.2 Perspectives
- 1.1 Code Area and Fence Plan
- 1.2 Site Plan Detailed
- 1.3 Fire Department Access & Compliance Layout
- 2.0 Proposed Main Level Plan
- 3.0 Elevations
- 4.0 Sections
- 4.1 Sections
- B2 Firewall
- C1 Ramp Profiles
- C2 Ramp and Truck Scale Drainage Schematic

# 

ALAMEDA COUNTY INDUSTRIES



# INDUSTRIES ion

COUNTY ation Ado

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AME

L Rev. L

This project will incorporate a structural design that does not increase the seismic force in any existing structural member by more than 10 percent cumulative since the original construction and does not decrease the the design strength of any existing structural element more than 5 percent cumulative since the original construction.

Structural Narrative

Additions will be structurally independent of the existing structure.

ACCURACY NOTE: THIS
BUILDING PLAN IS FOR
CONCEPTUAL USE ONLY. DO
NOT USE FOR DESIGN,
PERMITTING, OR
CONSTRUCTION.

PLANS OF EXISTING BUILDINGS ARE SCHEMATIC ONLY AND DO NOT SHOW ALL INTERIOR WALLS OR DOORS OR EXACT DIMENSIONS! Revision Number Description Date

K Rev. K 5-31-2017

6-26-2017

Project # 02-ET1491

WORKING DRAFT - L

6-26-2017

SHEET NUMBER

O.1
Cover Sheet

PROJECT # 02-ET1491



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ALAMEDA COUNTY INDUSTRIES Transfer Station Addition

 Revision Number
 Description
 Date

 K
 Rev. K
 5-31-2017

 L
 Rev. L
 6-26-2017

Project # 02-ET1491

WORKING DRAFT - L 6-26-2017


0.2
Perspectives


SHEET NUMBER

ALAMEDA COUNTY INDUSTRIES

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# **BUILDING AREA CALCULATIONS** FOR PROPOSED TRANSFER STATION ADDITION


Fire Sprinklers: Existing Office, Shop, and Material Recovery Facility (MRF) have fire sprinklers. Proposed Transfer Station to have fire sprinklers. Existing Risers in NE Corner of Maintenance Shop, and exterior NE corner of Existing Transfer Station. Existing FDC on Alladin Ave.

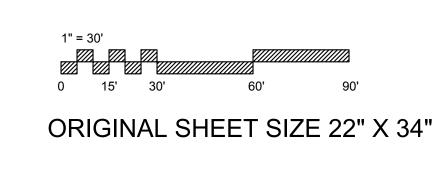Existing Construction:

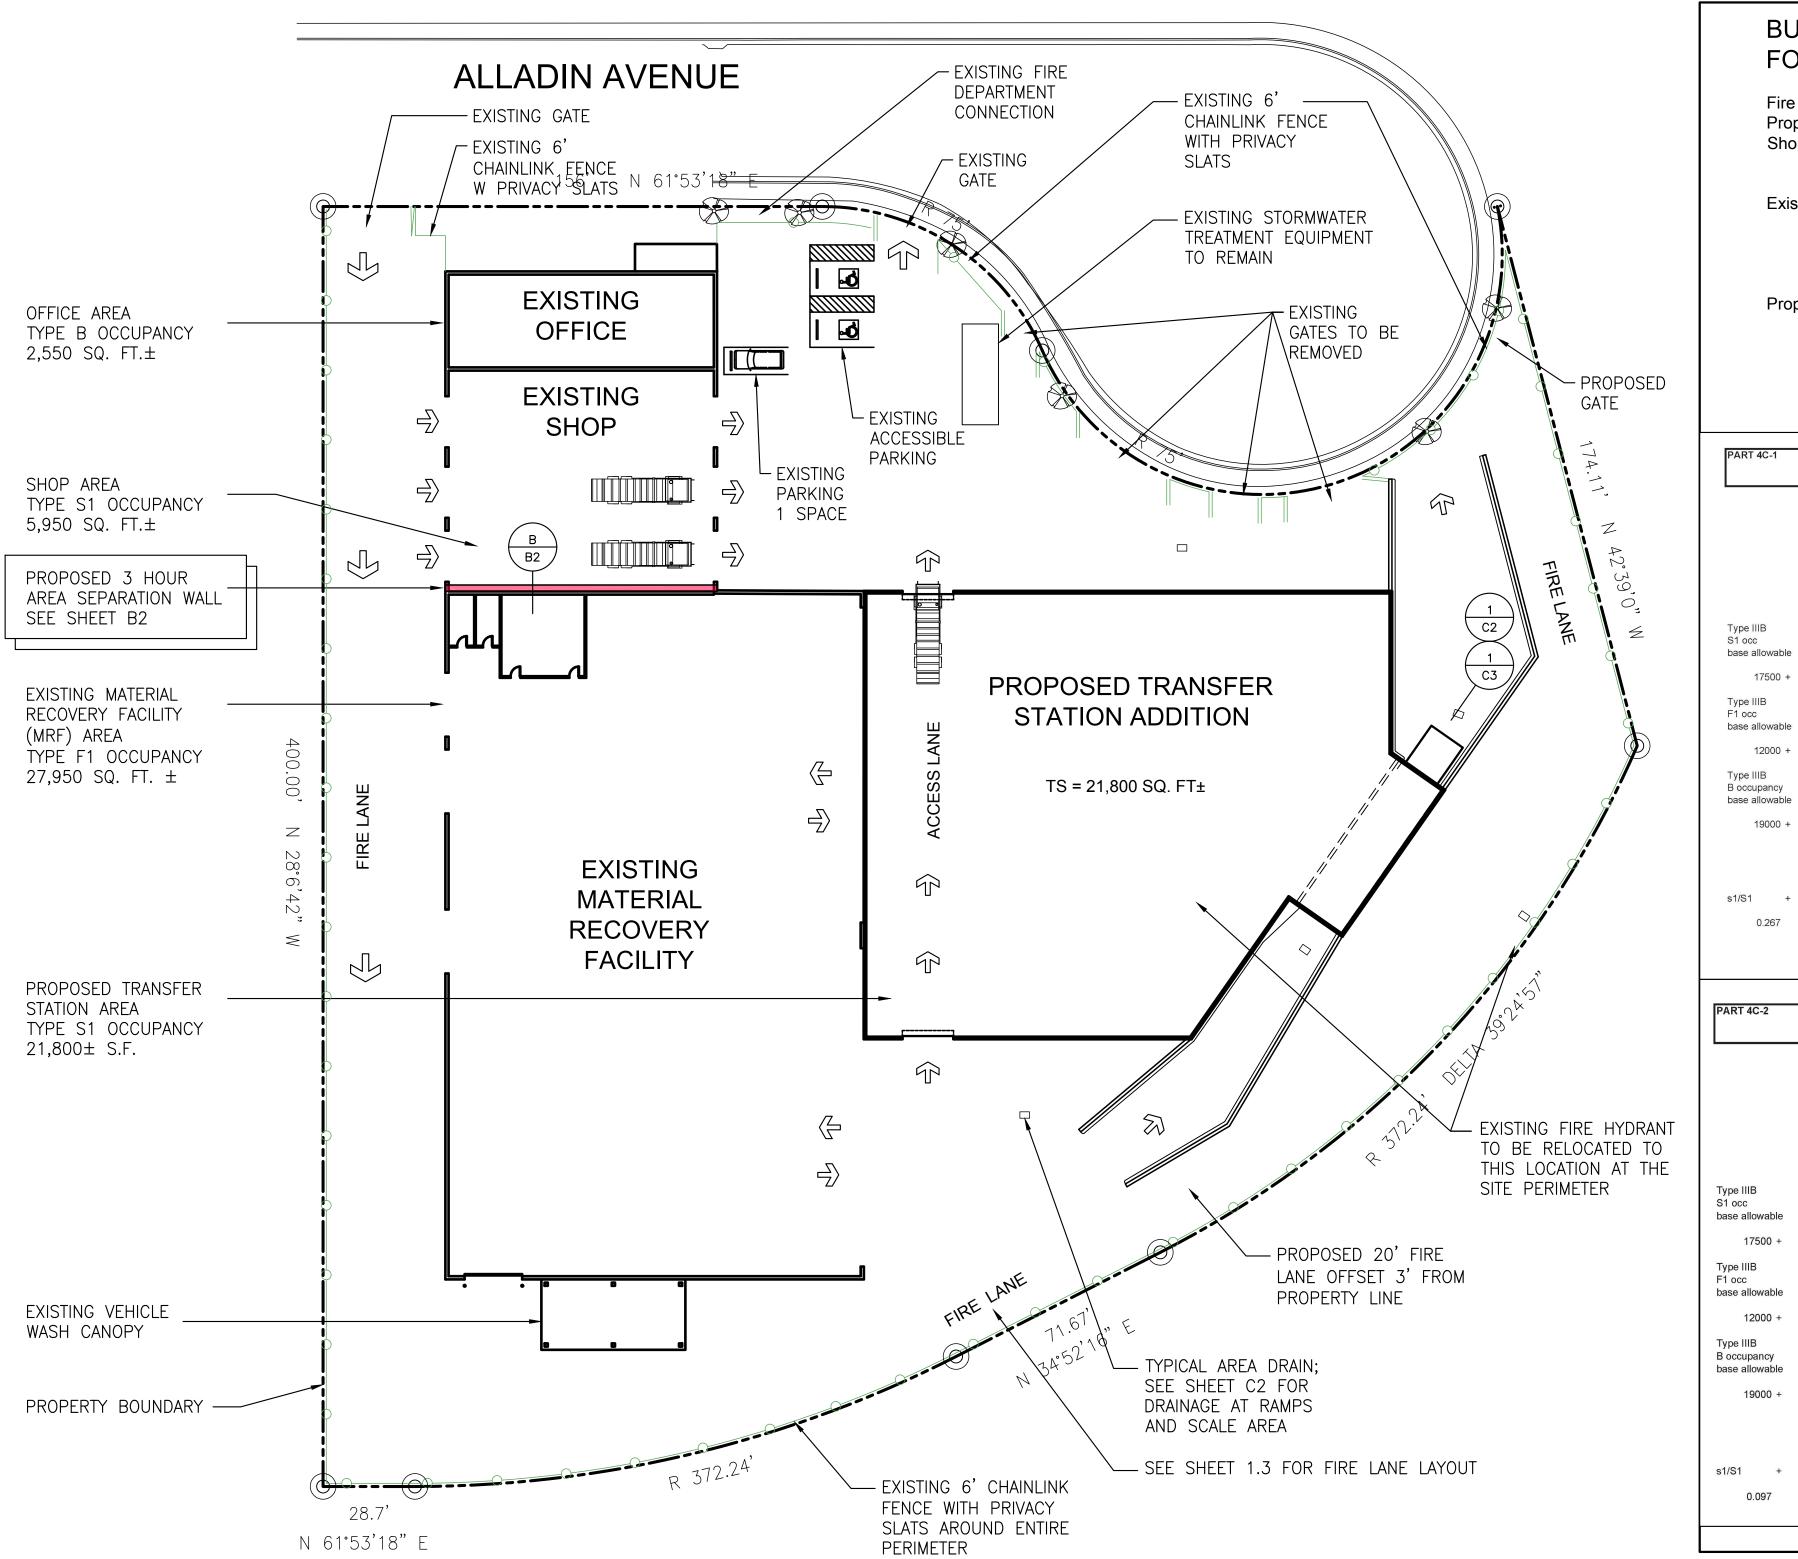Type IIIB and B Occupancy, 2,550 sf x 2 stories Office: Maintenance Shop: Type IIIB and S1 Occupancy, 5,950 sf x 1 story Type IIIB and F1 Occupancy, 27,950 sf x 1 story Mat. Recov. Facility


Proposed:

Type IIIB and F1 Occupancy, 21,800 sf x 1 story **Transfer Station** 

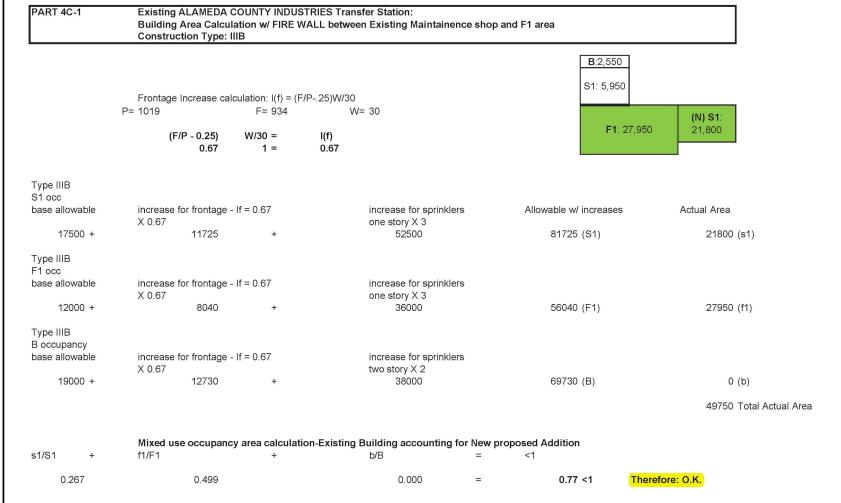

	Frontage Increase ca P= 370 (F/P - 0.25) 0.52	lculation: I(f) = ( F= 285 W/30 = 1 =	(F/P25)W/30 W= 30 I(f) 0.52		B:2,550 11: 5,950 F1: 27,950 (N) S1: 21,800	
Type IIIB						
S1 occ base allowable	increase for frontage X 0.52	- If = 0.52	increase for sprink two story X 2	allowable w/ in	creases Actual Area	3
17500 +	9100	+	35000	61600 (8	51) 595	60 (s1)
Type IIIB F1 occ base allowable	increase for frontage X 0.52	- If = 0.52	increase for sprink two story X 2	tlers		
12000 +	6240	+	24000	42240 (F	1)	0 (f1)
Type IIIB B occupancy base allowable 19000 +	increase for frontage X 0.52 9880	- If = 0.52 +	increase for sprink two story X 2 38000	clers 66880 (E		60 (b) 00 Total Ac
s1/S1 +	Mixed use occupand f1/F1	y area calcula +	tion-Existing Building accounting b/B	g for New proposed Addition = <1		
0.097	0.000		0.038	= 0.13 <	Therefore: O.K.	

Existing ALAMEDA COUNTY INDUSTRIES Transfer Station:

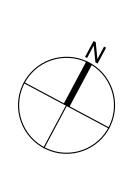

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Project # 02-ET1491

Date 5-31-2017

6-26-2017

Number Description K Rev. K


L Rev. L


**WORKING DRAFT - L** 6-26-2017


SHEET NUMBER

SITE PLAN

AREA CALCULATIONS LOT AREA: 123,046 SF (2.82 AC) (E) BUILDING FOOTPRINT: 36,450 SF (E) BUILDING FLOOR AREA: 39,000 SF (P) BUILDING FOOTPRINT: 21,800 SF (P) BUILDING FLOOR AREA: 21,800 SF TOTAL PROPOSED BUILDING FOOTPRINT: 58,250 SF FLOOR AREA RATIO: 0.49:1 LOT COVERAGE: 47.34% SETBACKS SETBACK LOCATION NORTHWEST AT OFFICE TO 20.28 ALADDIN AVE. NORTHWEST AT CULDESAC 30.18' 45.12' EAST AT BUILDING

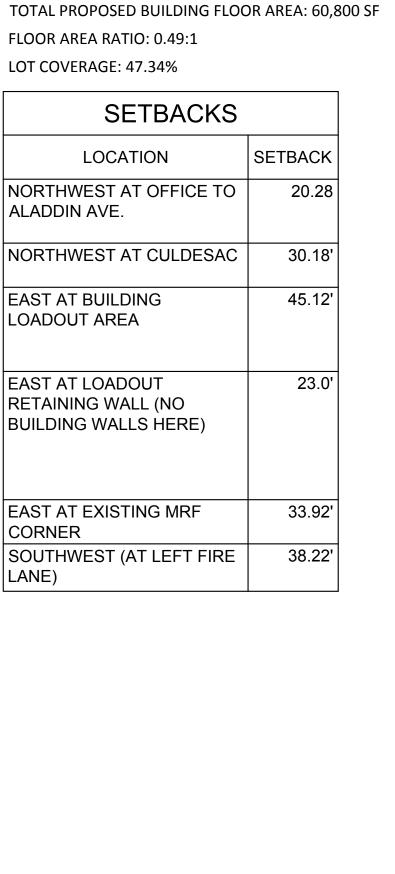

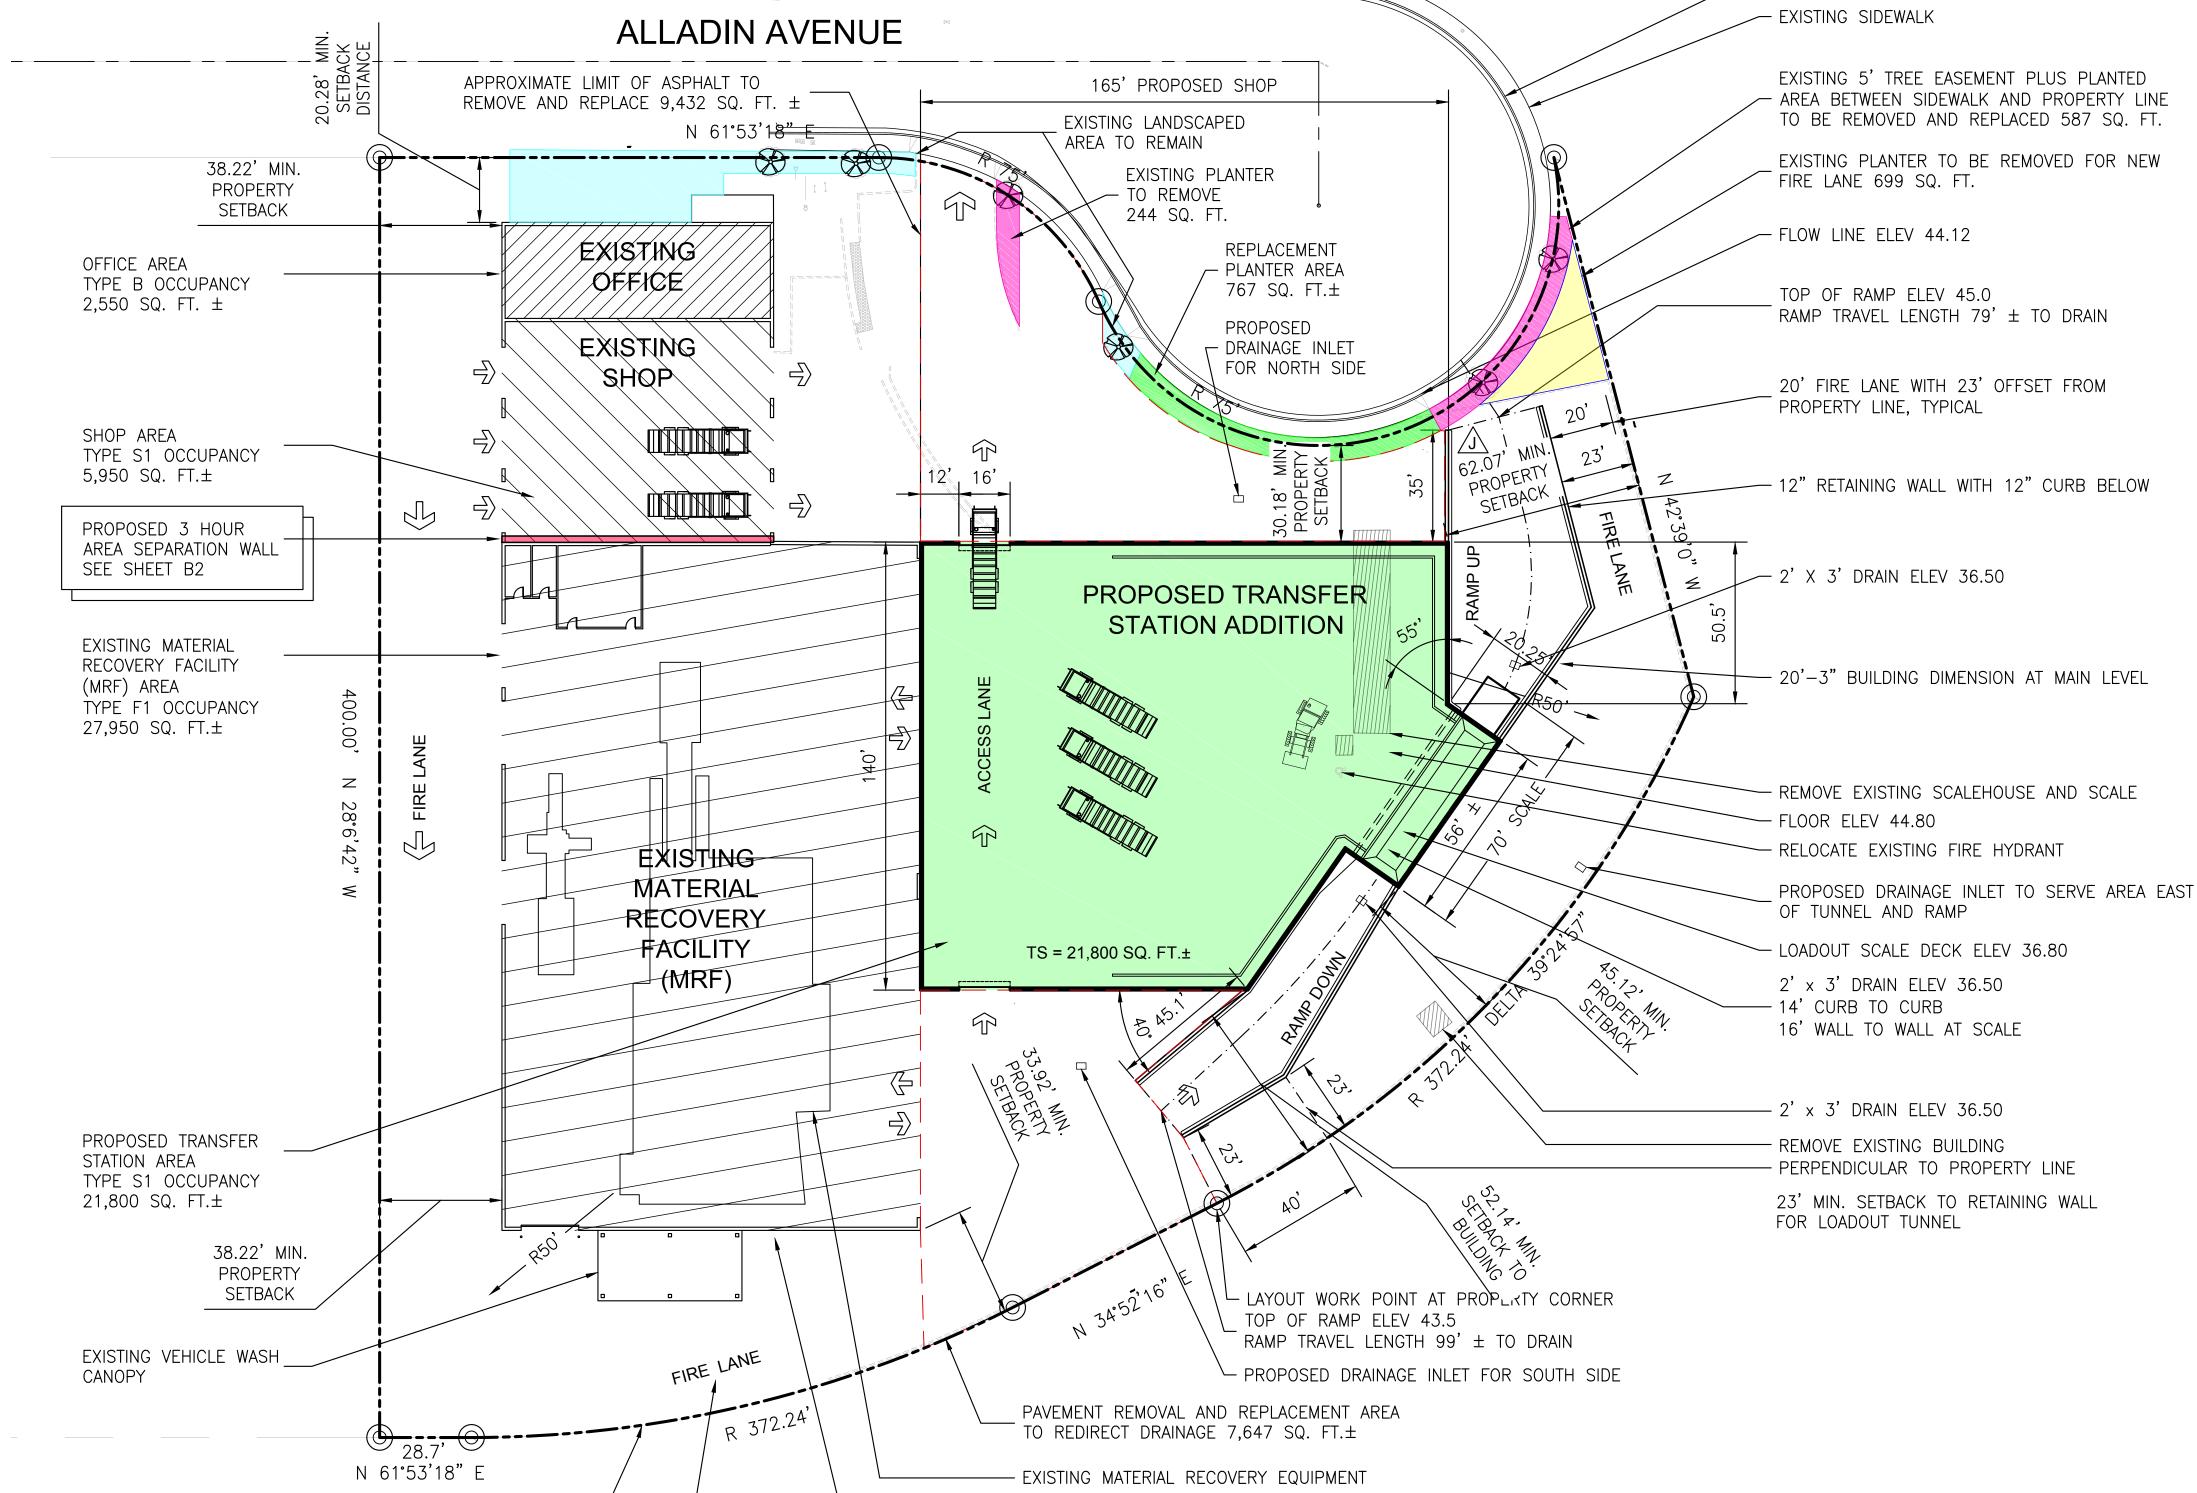

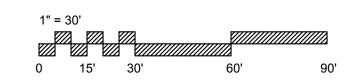

ORIGINAL SHEET SIZE 22" X 34"


SITE PLAN - DETAILED

- EXISTING BUILDING

1" = 30'

PROPERTY BOUNDARY —

SEE SHEET 1.3 FOR FIRE LANE ——

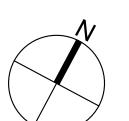





- EXISTING CURB AND GUTTER

# S Y S D atio CO<

610 Revision Number Description

K Rev. K

L Rev. L Date 5-31-2017 6-26-2017

Project # 02-ET1491

**WORKING DRAFT - L** 6-26-2017

SHEET NUMBER

SITE PLAN DETAILED

ALAMEDA COUNTY INDUSTRIES

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Required Fire Flow Calculations

The water supply shall be capable of providing the greater

- The automatic sprinkler system demand, including hose stream allowance
- b) The required fire-flow which is 1,500 gpm at 20 psi for 2 hours

The proposed new Transfer Station Addition building will be sprinklered throughout with an automatic sprinkler system which should be designed to the same occupancy classification as the existing building which is Extra Hazard Group I (0.30 gpm/sqft Over 2500 sqft.)

The resulting anticipated automatic sprinkler system demand for this system is 750 gpm discharging from the sprinkler system plus a 500 gpm hose stream allowance per NFPA-13-2016 requirements for a total automatic sprinkler demand of 1250 gpm.

The Required Fire Flow per city comments and CFC is 1,500 gpm at 20 psi for 2 hours.

The required fire flow is greater than the projected automatic sprinkler system demand and thus the fire flow is the controlling demand the water supply must be able to provide.

The water flow information from the site based on data from recent sprinkler system T.I.'s (F16-0060) is: 57 PSI Static


56 PSI Residual @ 1500 gpm flowing

Required fire flow of 1,500 gpm @ 20 psi is < 1,500 gpm @56 psi available from the water supply.

Thus, the results are:

The water supply (1,500 gpm at 56 psi) is capable of providing the greater of the anticipated automatic sprinkler system demand (1250 gpm @ approx 50 psi) and fire flow demand (1500 @ 20 psi).

reference: Walschon Fire Protection Inc. 3/1/2017

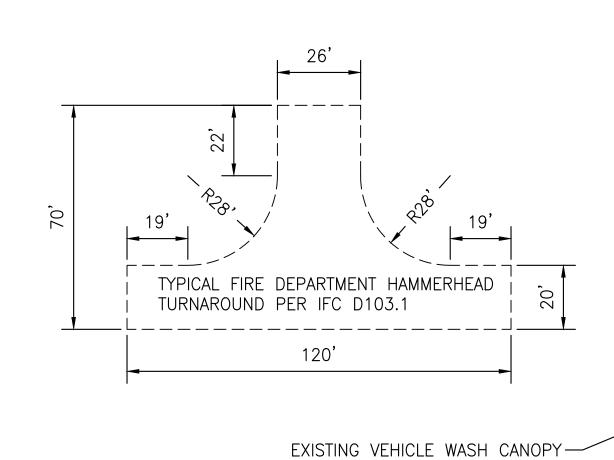


SU-40 TURN TEMPLATE

ORIGINAL SHEET SIZE 22" X 34"



— EXISTING BUILDING

5/31/2017 - NEW SHEET 1.3

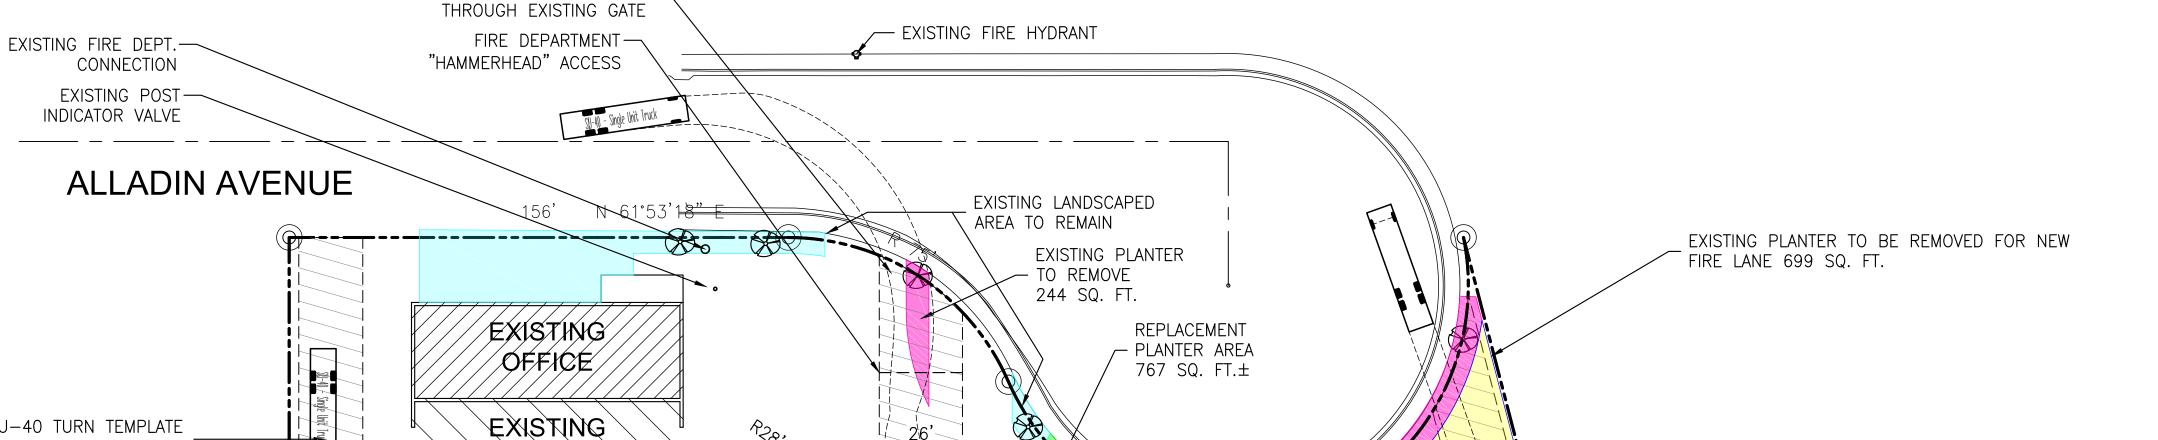

(AASHTO 2011) (TYP.) SHOP 20' FIRE LANE WITH 23' OFFSET FROM PROPERTY LINE, TYPICAL 12" RETAINING WALL WITH 12" CURB BELOW

TS = 21,800 SQ. FT.±

FIRE DEPARTMENT ACCESS—

EXISTING

RECOVERY

**FACILITY** 

(MRF)

N 61°53′18″ E

PROPERTY BOUNDARY —

MATERIAL

PROPOSED TRANSFER STATION ADDITION

-LOADOUT SCALE DECK ELEV 36.80

TOP OF RAMP ELEV 43.5

─SU-40 VEHICLE BACKING INTO FIRE

-PROPOSED FIRE HYDRANT LOCATION

DEPARTMENT HAMMERHEAD TURNAROUND

RAMP TRAVEL LENGTH 99' ± TO DRAIN

FIRE DEPARTMENT PARALLEL ACCESS POINT SHOWING SU-40 VEHICLE TURN

-PROPOSED FIRE HYDRANT LOCATION

-REMOVE AND RELOCATE EXISTING FIRE HYDRANT

Date 5-31-2017 6-26-2017

Project # 02-ET1491

**WORKING DRAFT - L** 6-26-2017

SHEET NUMBER

FIRE DEPT. LAYOUT

INDUSTRIES

Design, Permitting, or Construction

Project # 02-ET1491

Revision Number Description

K Rev. K

L Rev. L


WORKING DRAFT - L 6-26-2017

SHEET NUMBER


Elevations

ORIGINAL SHEET SIZE 22" X 34" PROJECT # 02-ET1491

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2 Section at Existing TS Looking North
4.0 1" = 20'-0"

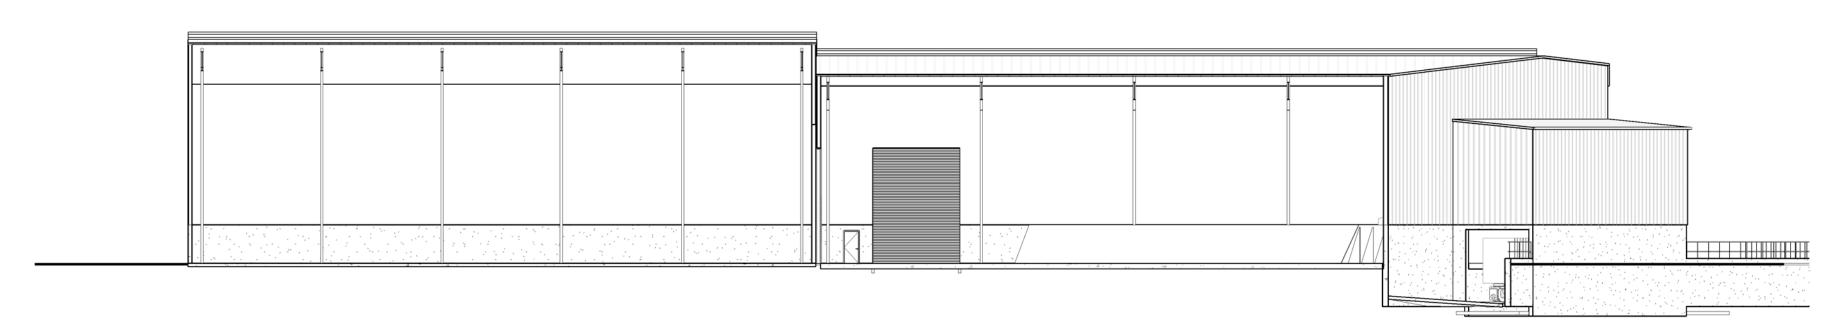

3 Interior View of Loadout 4.0 3/32" = 1'-0" Revision Number Description

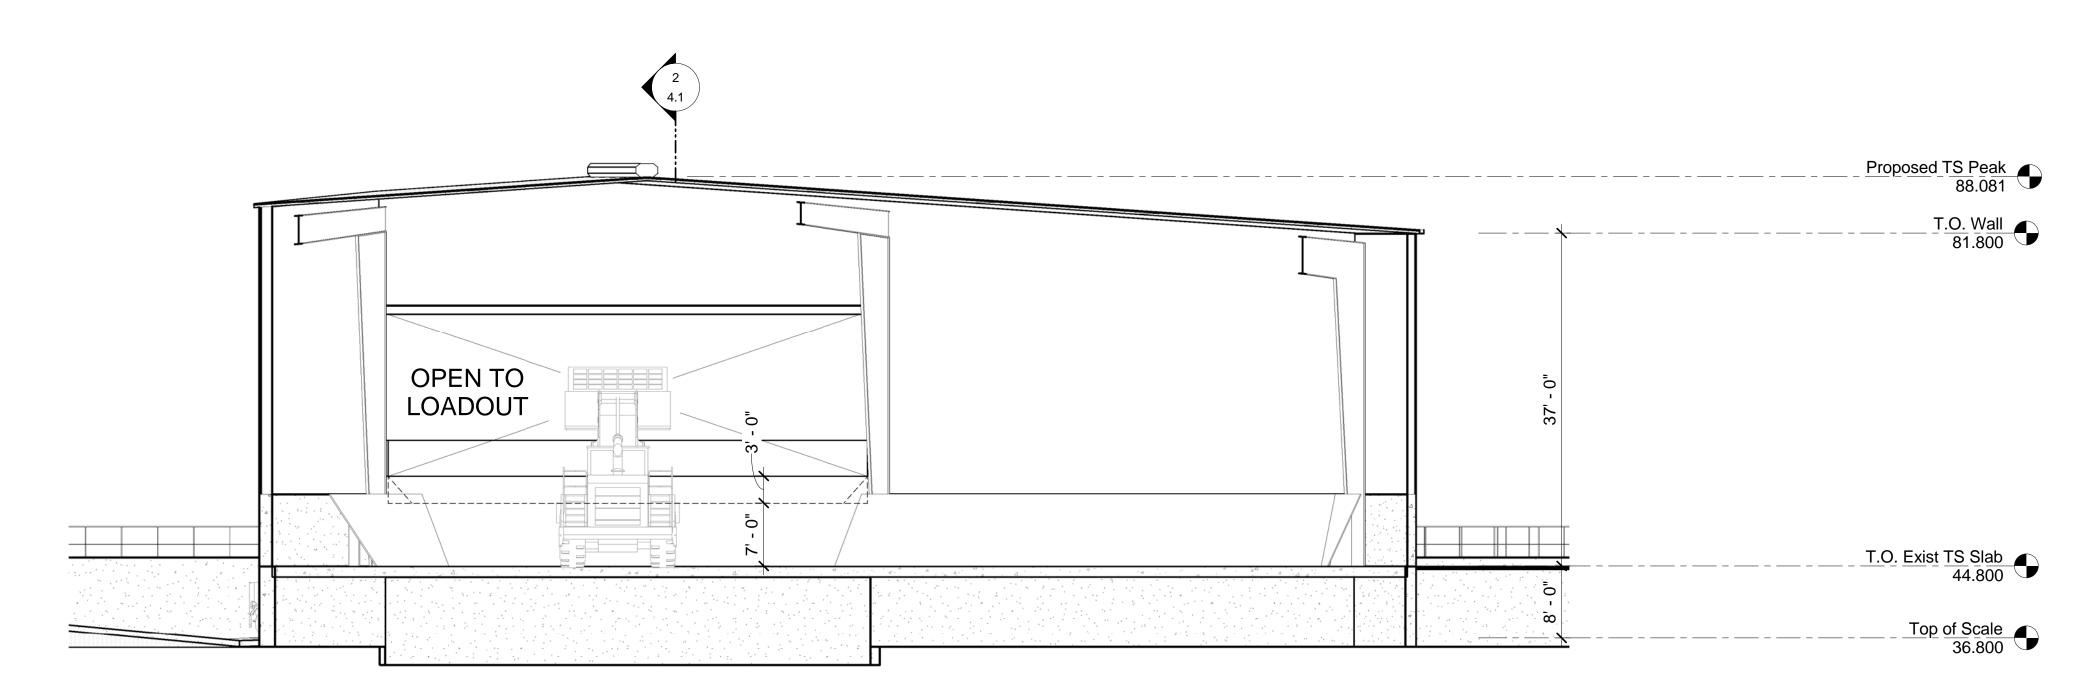K Rev. K

L Rev. L

Project # 02-ET1491

WORKING DRAFT - L

6-26-2017

SHEET NUMBER

Date 5-31-2017 6-26-2017

ORIGINAL SHEET SIZE 22" X 34"
PROJECT # 02-ET1491

ORIGINAL SHEET SIZE 22" X 34" PROJECT # 02-ET1491

ORIGINAL SHEET SIZE 22" X 34"

ALAMEDA COUNTY INDUSTRIES



# AMEDA COUNTY INDUSTRIES ansfer Station Addition

A

Number Description
K Rev. K

L Rev. L

610

Date 5-31-2017 6-26-2017

Project # 02-ET1491
WORKING DRAFT - L

6-26-2017 FIRE WALL LAYOUT

SHEET NUMBER

B2



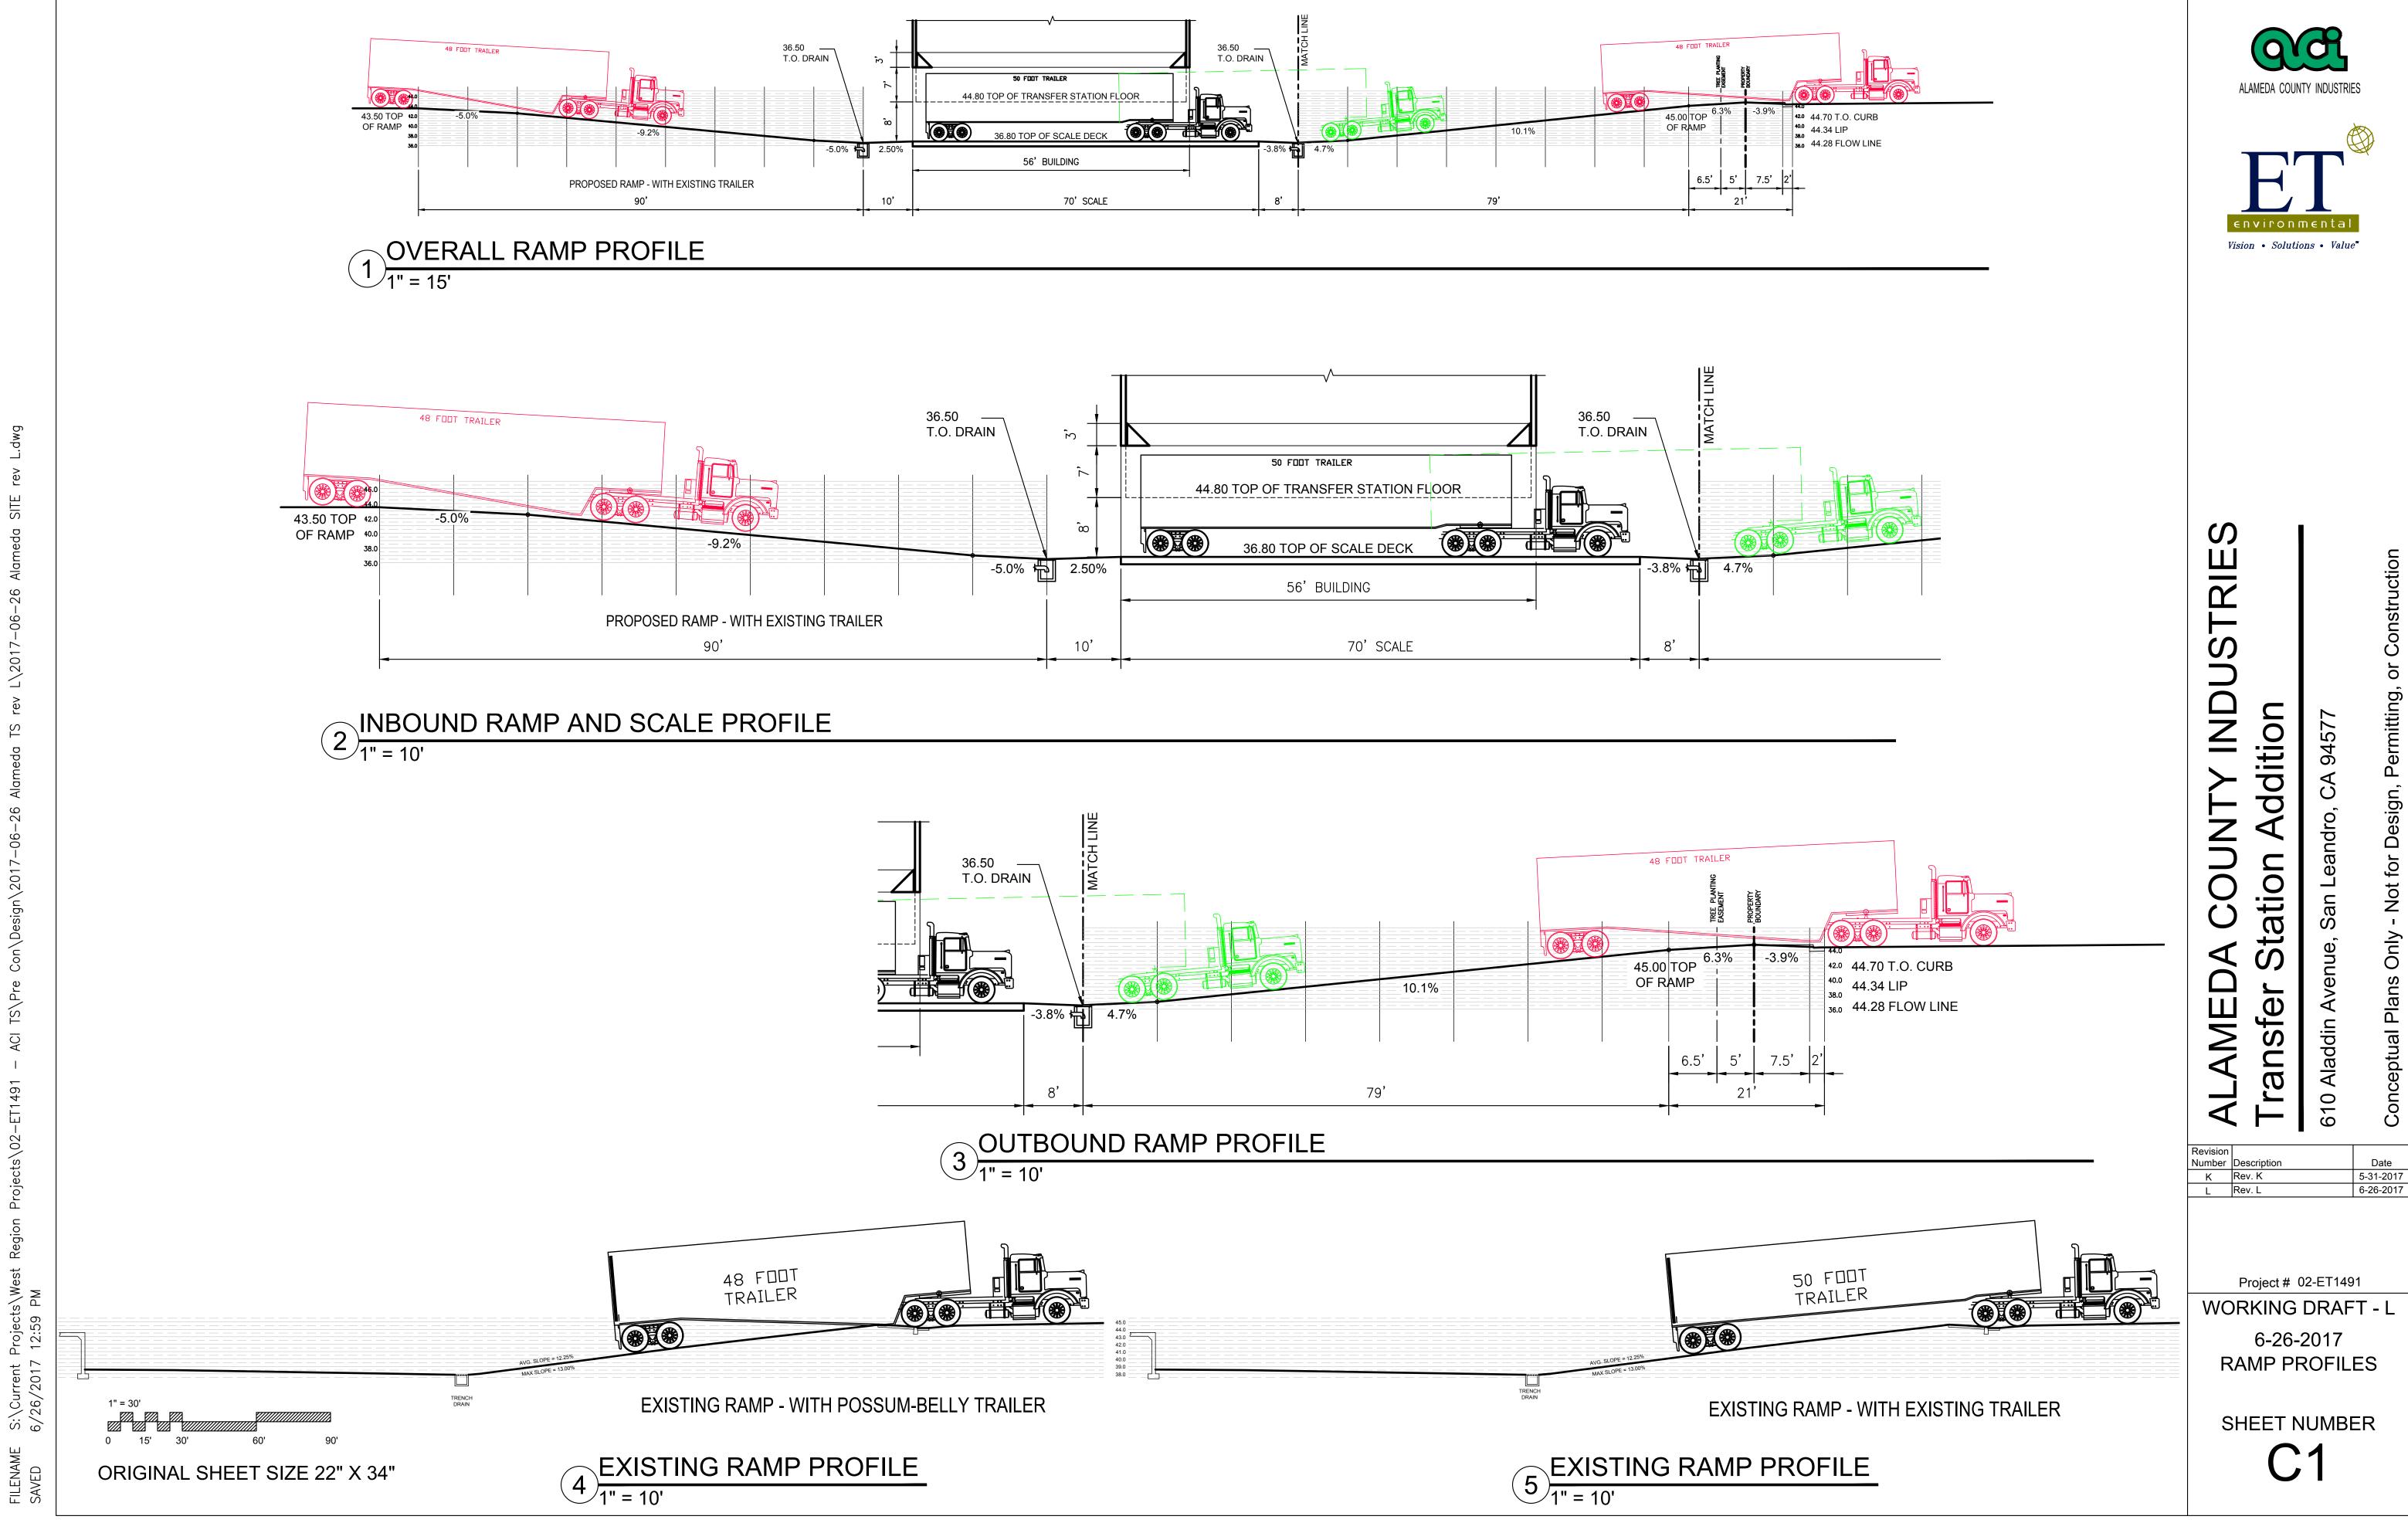


EXHIBIT K

Date 5-31-2017 6-26-2017

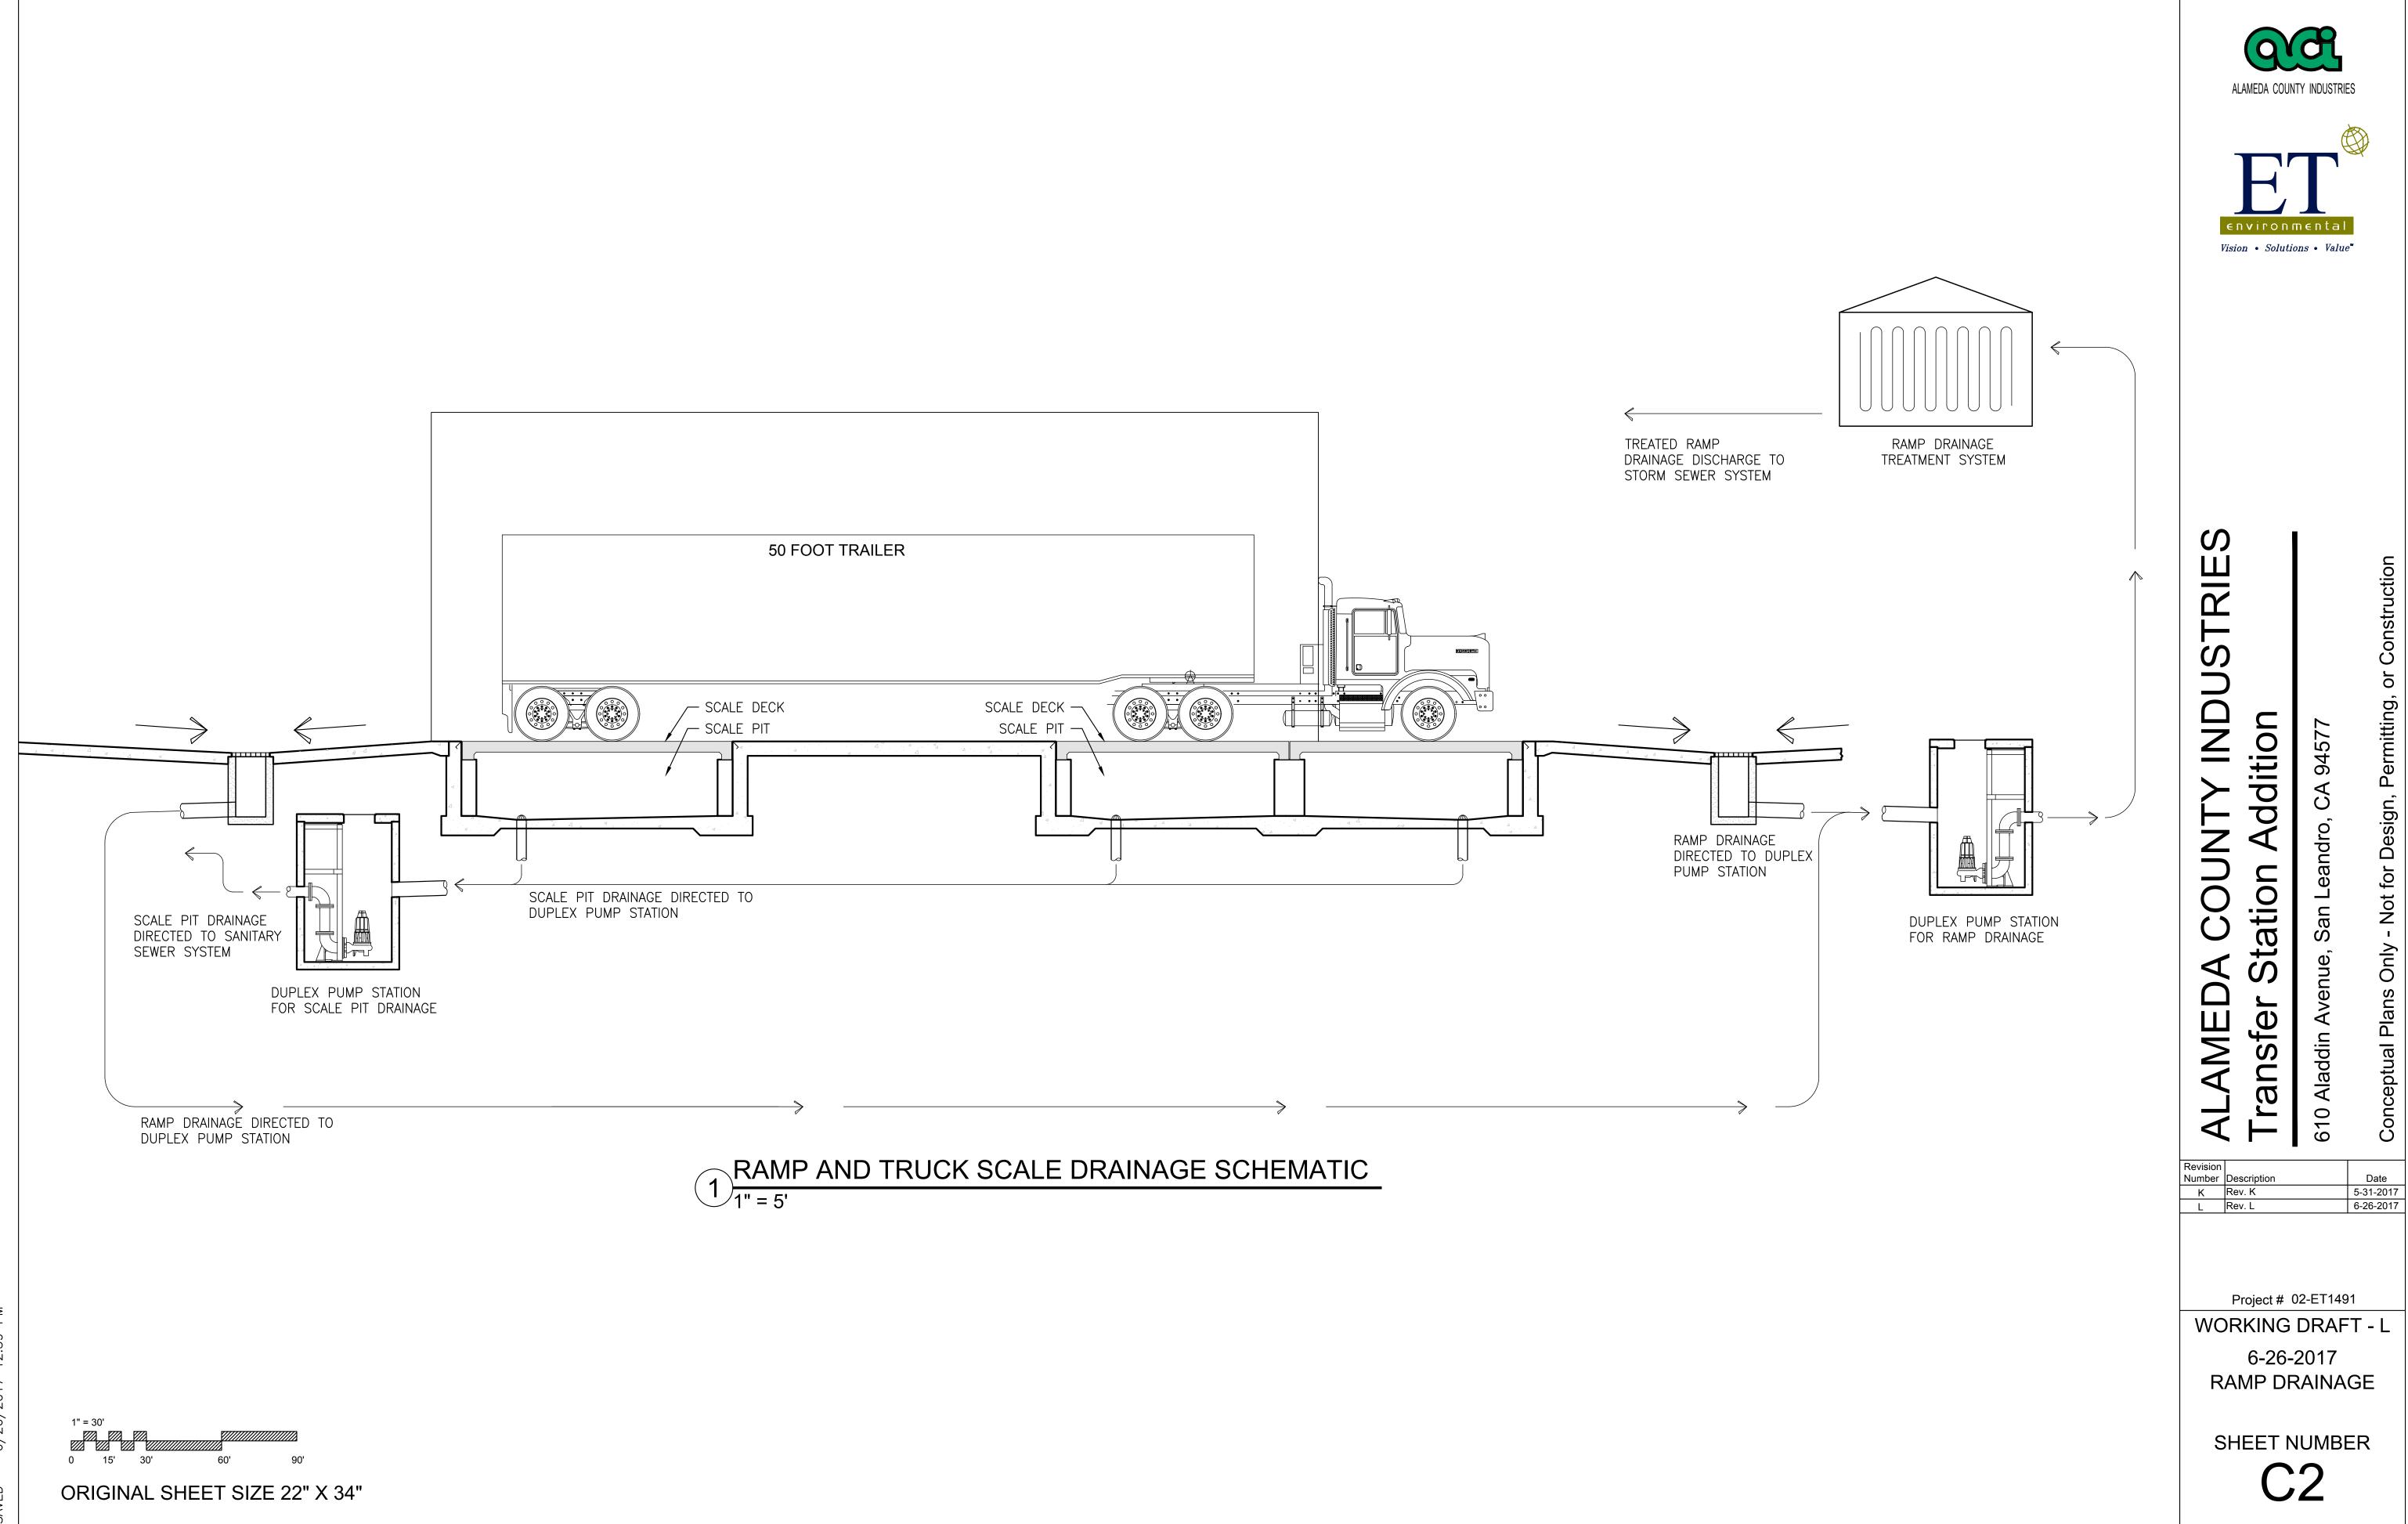

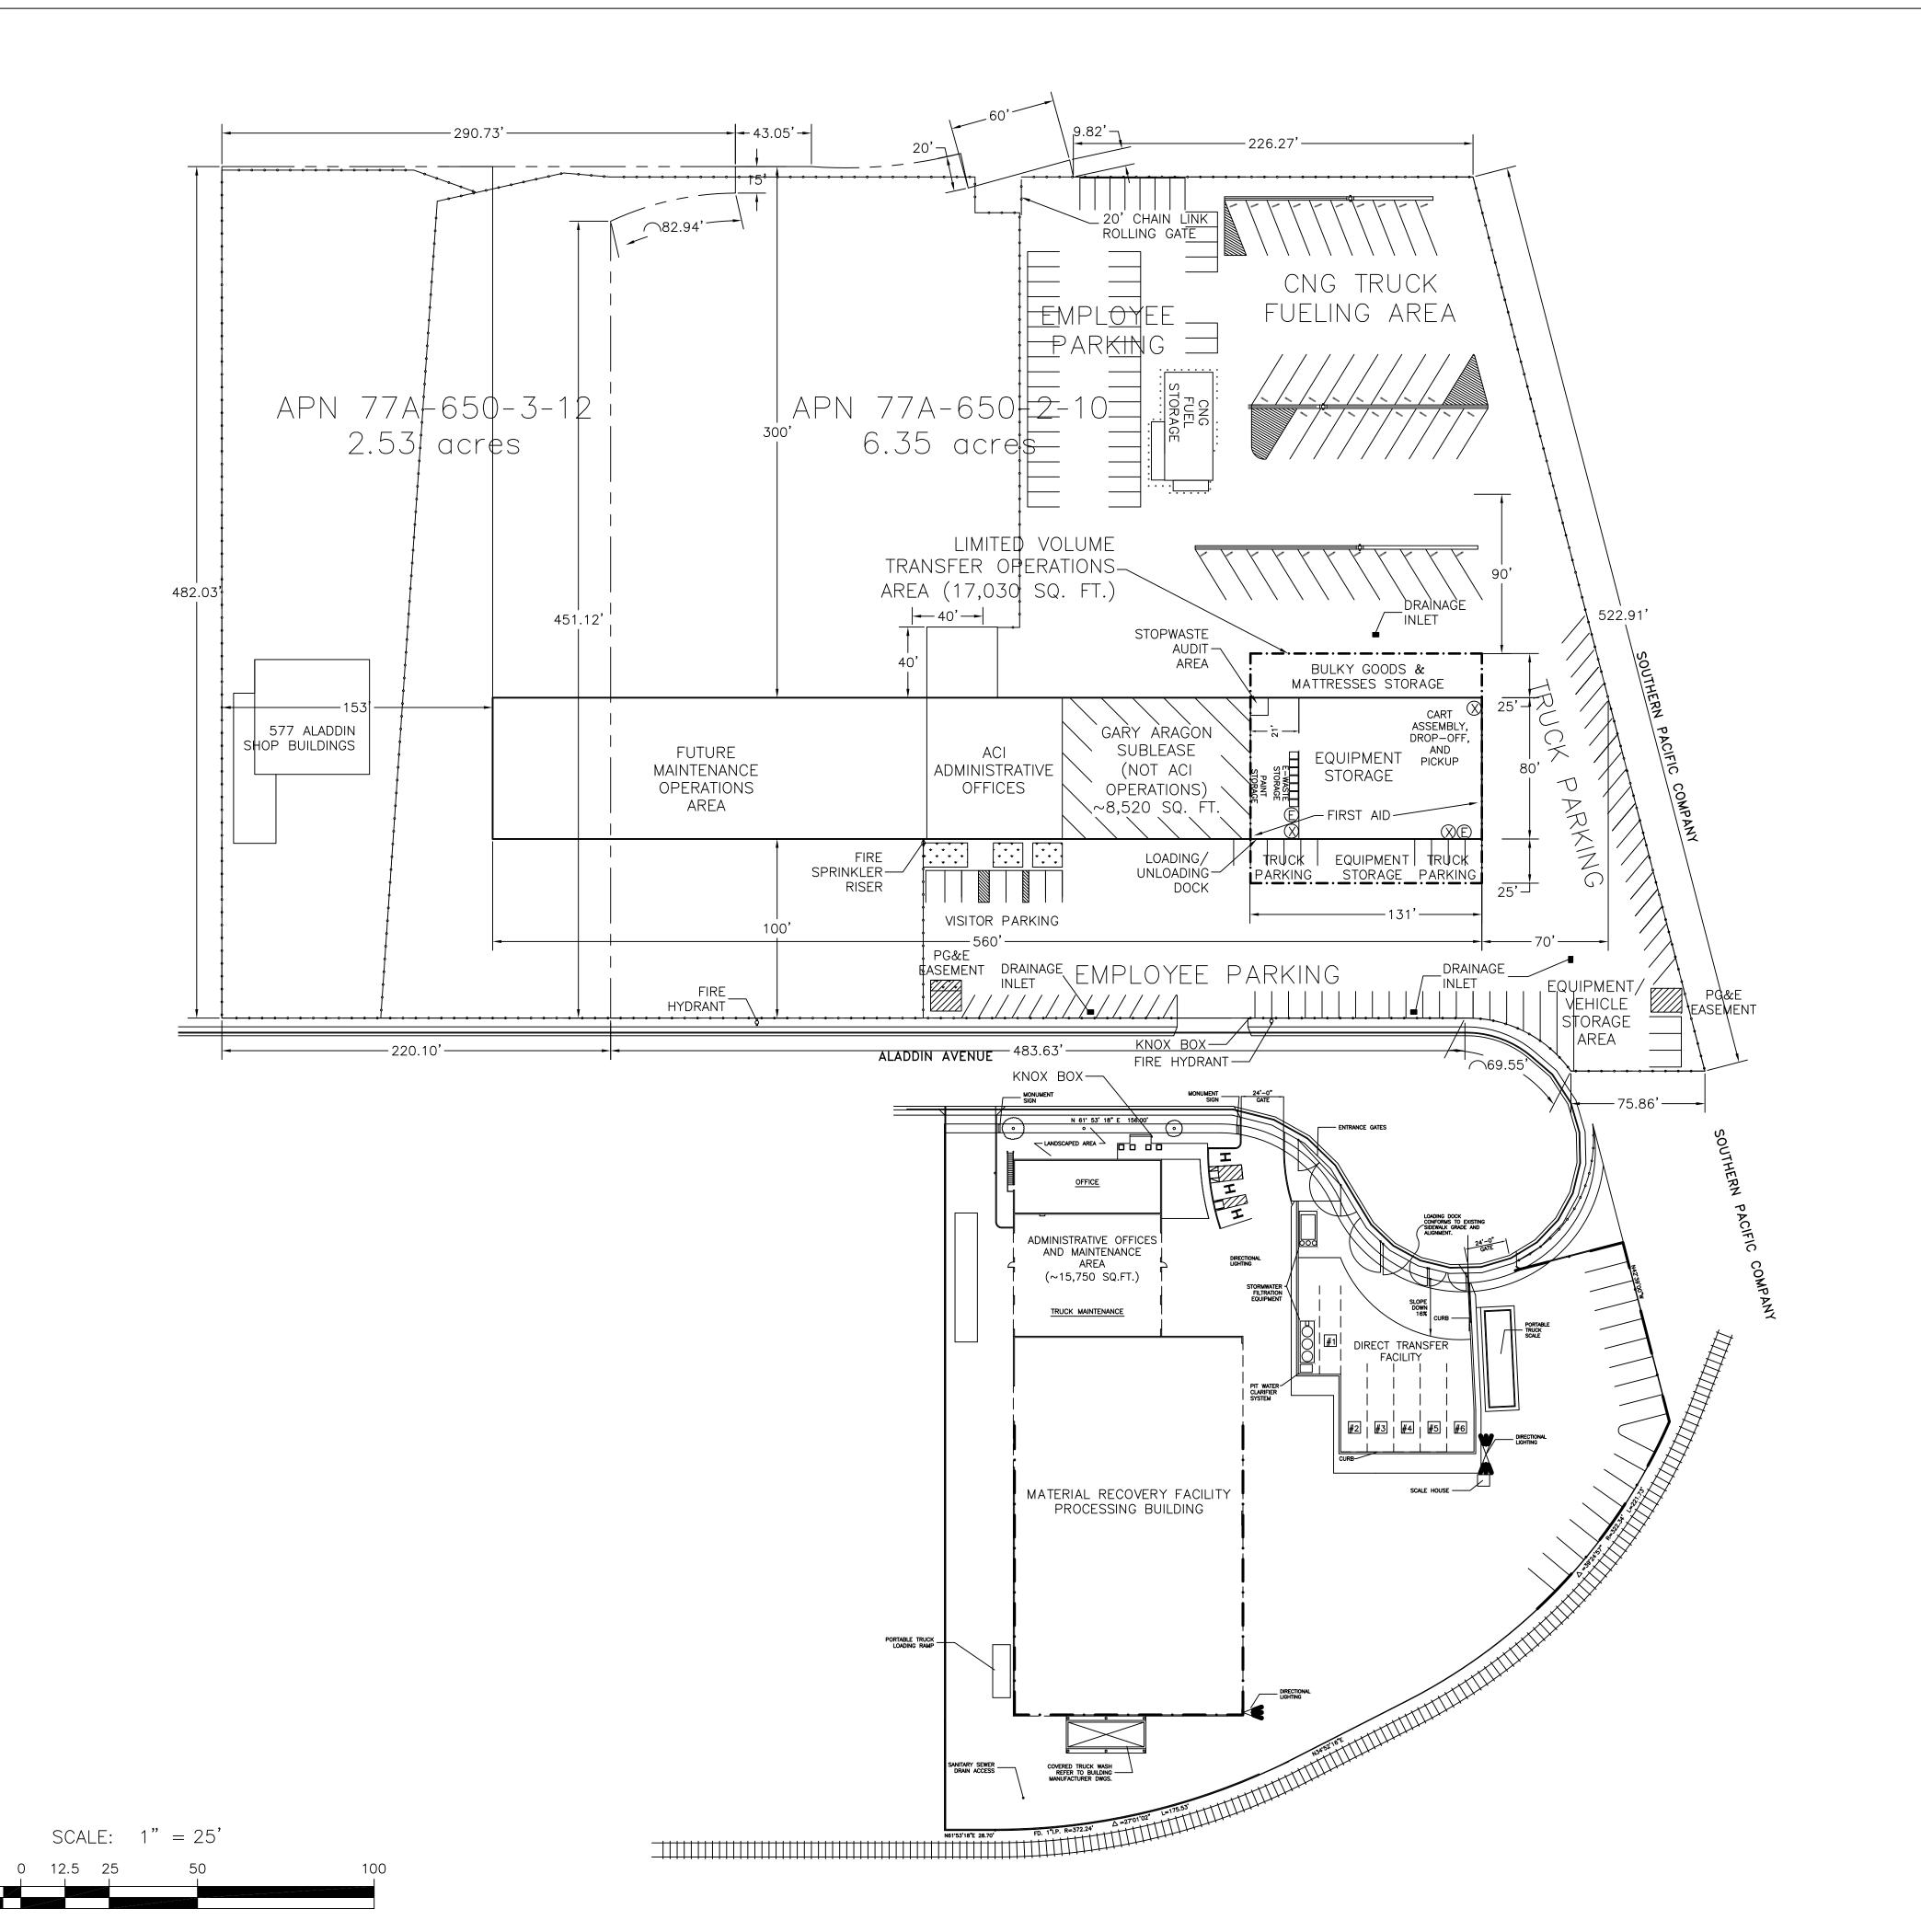

# <u>PROJECT DATA</u>

ZONING: IG

BUILDING HEIGHTS: < 35'

LOT AREA: APN 77A-650-2-10 <u>APN 77A-650-3-12</u>

6.35 ACRES 2.53 ACRES 8.88 ACRES

386,800 SQ. FT.

(E)MAIN PROJECT BUILDING AREA (E) 577 SHOP BUILDINGS TOTAL

TOTAL

48,556 SQ. FT. 5,700 SQ. FT. 54,256 SQ. FT.

FLOOR AREA RATIO LOT COVERAGE .14:1 14.03%

PROJECT BUILDING IS METAL FRAMED/METAL EXTERIOR WITH WHITE EXTERIOR PAINT AND GREEN TRIM.

PROPERTY BOUNDARY	SETBACK DISTANCE
NORTH	300 FEET
SOUTH	100 FEET
EAST	70 FEET
WEST	153 FEET

# LEGEND

EYEWASH STATION
FIRE EXTINGUISHER
PROPERTY LINE
6' CHAIN LINK FENCE

LA

LANDSCAPE AREAS

TOTAL COMPLIANCE MANAGEMENT

1822, 21ST STREET
SACRAMENTO, CALIFORNIA 95811
PHONE: (916) 739–1700
FAX (916) 739–1216

SCALE:
1" = 25'
CIENT:
170.32 SLD/ACI
DATE:
MARCH 30, 2017
FILE NAME:
SAN LEANDRO, CALIFORNIA 94577
FIGURE
1

1

FIGURE
1

ALAMEDA COUNTY INDUSTRIES
610 ALADDIN AVE.
SAN LEANDRO, CALIFORNIA 94577
ORIGINAL DATE:
03/28/17