EXHIBIT A - COVER SHEET

LEANDRO. THE PROJECT PROPOSE) CONSTRUCT A SUSTAINABLE DEVELOPMENT IN ACCORDANCE WITH THE CITY OF SAN ES A FULL DEMOLITION OF THE EXISTING STRUCTURE, AND A PLANNED DEVELOPMENT INNUMS TO COMPLY WITH REQUIRED CODES AND REGULATIONS.	LEWELLING CONDOMINIUMS	
PROJECT SCOPE		874 LEWELLING BLVD. SAN LEANDRO, CA 94579	
1. APPLY FOR A PLANNED DEV 2. PROPOSE TO CHANGE ZON	VELOPMENT PROJECT		
 DEMOLISH EXISTING BUILDI PROPOSE 2 BUILDINGS 	ING		
 BLDG A: 4 DWELLING UNITS, PROPOSE OFF-STREET PAR PROPOSE COMMON OPEN S 	; BLOG B: 2 DWELLING UNITS KKING SPACE		
 PROPOSE HARDSCAPE TO E 	BE OF PERMEABLE PAVERS		1 64 75
WNER / CONSULTANT	INDEX		C. Same
WNER:	BAY HOME INVESTMENTS & LOANS, INC. 17331 HESPERIAN BLVD. SAN LORENZO, VA 94580		Alle a
	(C) 510-364-1179 (W) 925-980-8863 BROKERHUNAG@ATT.NET		A MONT
RCHITECT / APPLICANT:	GKW ARCHITECTS, INC. GORDON K WONG, ARCHITECT AIA, LEED GA 710 E. MGGLINCY LANE, SUITE 109, CAMPBELL, CA 95008		14
	710 E. MCGUINCY LANE, SUITE 109, CAMPBELL, CA 95008 (408) 315-2125 GORDONKWONG@GKWARCHITECTS.COM		12-
FRUCTURAL ENGINEER:	BETTA GROUP, INC. / STRUCTURAL ENGINEERING CO. 2053 LINCOLIN AVENUE, SUITE A, SAN JOSE, CA 95125		- 1
	408-267-7190 ASHUR@BETTA-GROUP.COM		The second
VIL ENGINEER:	LC ENGINEERING / NINH LE, PE, QSD 598 E SANTA CLARA ST, STE 270, SAN JOSE, CA 95112 409 690 7497 JUL EEM CONTINEERDING NET		Station 1
	408-806-7187 NLE@LCENGINEERING.NET		1
ANDSCAPE ARCHITECT:	JEFFREY HEID, LANDSCAPE ARCHITECT 6179 ONEIDA DRIVE, SAN JOSE, CA 95123 WHEIDASLAGGINALL.COM		
			ह आजि
TLE 24 ENERGY CONSULTANT :	CARSTAIRS ENERGY TIMOTHY CARSTAIRS, CEA, HERS, GPR PO BOX 4736 SAN LUIS OBISPO, CA 39403 805 994 948 TITLE24@YAHOD.COM WWW.CARSTAIRSENERGYCALCS.COM		A 100
			1 16
ROJECT CONTACT IND			and a
TY OF SAN LEANDRO, BUILDING	PERMIT CENTER 835 EAST 14TH STREET, SAN LEANDRO, CA 94577 510-577-3200 (CITYCOMMENTS@SANLEANDRO.ORG		Value III
ATED & SEWAGE PEDMOEP			T DEMAN
ATER & SEWAGE SERVICES	EBMUD EAST BAY MUNICIPAL UTILITY DISTRICT 375 11TH STREET, OAKLAND, CA 94607 OFFICE 868-403-2683 (CUSTOMER SERVICES@EBMUD.COM		2.00
ACIFIC GAS & ELECTRIC CO.	UTILITY CO. (HAYWARD)		
	011117 CO. (MATWARD) 24300 CLAWITER ROAD, HAYWARD, CA 94545 800-743-5000		
T&T	800-288-2020 24 HOURS A DAY		
	800-924-9420 BURIED WIRE CENTER	BUILDING INFORMATION MODEL	SHEET INDEX
DMCAST	RESIDENTIAL SERVICE 855-899-9035 CUSTOMER SERVICE 800-266-2278		
PROJECT SUMMARY			Sheet Numbe
LIENT:	BAY HOME INVESTMENTS & LOANS, INC.		G000 G001 G002
DDRESS:	874 LEWELLING BLVD., SAN LEANDRO, CA 94579	And in a set of a set of the set	G002 G003 G004
PN:	80G-1114-3-2	and a state of the	G004 G005 G006
URISDICTION: DT SIZE	CITY OF SAN LEANDRO, CA 0.48 ACRE (20.829.74 SF)	THE REPORT OF THE PARTY OF THE	G007
ENERAL LAND USE:	U48 AGRE (20,829,74 SF) MEDIUM DENSITY		T1 C1
E) ZONING:	RESIDENTIAL SINGLE FAMILY (RS)		C2 C3
) ZONING:	RESIDENTIAL MULTI-FAMILY DISTRICT (RM-3000)	FRONT VEW	C4 C5
P) OCCUPANCY: XISTING USE:	R-3 SINGLE FAMILY RESIDENTIAL		C6 C7
ROPOSED USE:	MULTI-FAMILY RESIDENTIAL		C8 C9
PE OF CONSTRUCTION:	IBC TYPE V-B, SPRINKLERED		L1 L2
JTO-SPRINKLER SYSTEM:	13D - SINGLE FAMILY WATER LINE		L3 L4
UILDING INFORMATION	N UNIT & LOT COVERAGE BREAKDOWN		L5 A100 A101
ROPOSED NUMBER OF UNITS:	6 DWELLING UNITS		A101 A102 A103
UILDING FOOTPRINT: BUILDING A	BLDG UNIT # # BEDRMS # BATHRMS TTL SF, GR 2,888 SF 1 3 3 2480 SI		A200 A201
BUILDING B BUILDING TTL	1 3 3 2480 SI 5,980 SF 2 3 3 2,192 SI	the second se	A300 A301
AXIMUM LOT COVERAGE:	20,830 SF X 50% = 10,415 SF	REAR VIEW	A400 A500
ROPOSED LOT COVERAGE:	6,143 SF 6,143 SF/20,830 SF = 29%	VICINITY MAP	E1.1
ENSITY ALLOWED:	14.5 DU/ACRE B 5 4 3 2,549 Si 6 4 3 2,549 Si	1. CONTRACTOR IS RESPONSIBLE FOR DUST CONTROL AND INSURING AREA ADJACENT TO WORK IS LEFT IN A CLEAN CONDITION. 2. UTILIZE BEST MANAGEMENT PRACTICIZES (BMPS), AS REQUIRED BY THE STATE WATER RESOLICES BOARD, FOR MAY ACTIVITY.	
ROPOSED UNITS:	6 DU = 14.5 DU X.48 ACRE TOTAL 14.415 S	WHICH DISTURBES SOLL 3. CONTRACTOR SALL SACKE OR FIRE DAMAGED MEMBERS CLEAN, ANY FRAMING MEMBERS THAT LOSE MORE THAN 3. CONTRACTOR SHULL SCARAPE ALL SMOKE OR FIRE DAMAGED MEMBERS THAT LOSE MORE THAN	
ROPOSED UNIT SF TOTAL: ROPOSED PARKING COUNT:	17,776 SF 12 COVERED + 2 GUEST + 1 ADA = 15 LOT COVERAGE BREAKDOWN	TROJAN AVE 48 TROJAN	
ARKING & CIRCULATION:	7,894 SF BLDG UNIT# LOT AREA BLDG PAD		
PERVIOUS AREA) OTAL OPEN SPACE:	1 1,127 SF		
PERVIOUS AREA)	2 1,022 SF 2,988 SF 237 SF A 3 1,022 SF	SANLEADORD STANDARD PLAND MOK. NO. 20. ALL ROPOSED STORM IDER TRANSIC APURE DEVICES.	
	23/ 0F - 1,022 0F	Applicable codes	SITE PLAN NOTES
O-RETENTION AREA:	4 1,095 SF		1. CONTRACTOR TO V

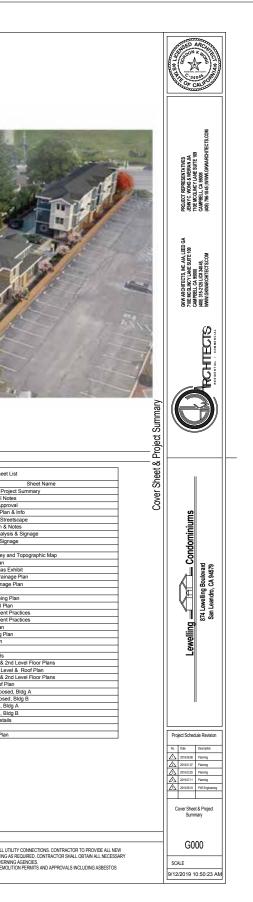


EXHIBIT B - PROJECT NOTES

GENERAL NOTES	PROJECT REPORTS / STUDY(S) / ASSESSMENT / OUT REACH	ABBREVIATIONS				
GENERAL NOTES 1. IT IS THE RESPONSIBILITY OF THE CONTRACTOR AND SUBCONTRACTORS TO CHECK AND VERIFY ALL DIMENSIONS AND CONDITIONS INDICATED ON THESE DRAWINGS AND MAKE KNOWN ANY DISCREPANCIES PRIOR TO COMMENCING THEIR WORK. 2. ALL WORK SHALL BE PERFORMED IN ACCORDANCE WITH ALL APPLICABLE REGULATIONS INCLUDING BUT NOT LIMITED TO NATIONAL, CITY, STATE, LOCAL CODES AND ORDINANCES WHICH MAY BE IN EFFECT. ALL MATERIALS, INSTALLATION PROCEDURES AND PLANS SHALL BE APPROVED BY ALL APPLICABLE CODE ENFORCEMENT AUTHORITIES HAVING JURISDICTION, AND IT SHALL BE THE CONTRACTORS RESPONSIBILITY TO OBTAIN AND PAY FOR ALL NECESSARY PERMITS AND APPROVALS FOR THE WORK. 3. THESE DRAWINGS ARE INTENDED FOR USE IN A NEGOTIATED CONSTRUCTION CONTRACT AND THEREFORE, MAY NOT SPECIFICALLY DETAIL OR SPECIFY MATERIAL AND / OR MANUFACTURERS. THE CONTRACTOR SHALL PROVIDE ALL SAMPLES AND OR CUTS AS REQUIRED TO ASSIST OWNER OR HIS AGENT IN MAKING MATERIAL SELECTIONS. FOR THE PURPOSE OF ESTIMATING, THE CONTRACTORS SHALL USE THE MATERIALS SELECTED BY THE OWNER, OR IN ABSENCE OF SAME. SHALL PROVIDE AN ALLOWANCE AMOUNT AND SO CONDITION ANY COST ESTIMATE. ALL MATERIALS SPECIFIED IN THESE DRAWINGS SHALL BE INCLUDED IN SUCH ESTIMATE. 4. NO GUARANTEE OF QUALITY OF CONSTRUCTION IS IMPLIED OR INTENDED BY THE ARCHITECTIRAL DOCUMENTS, AND THE CONTRACTOR SHALL ASSUME FULL RESPONSIBILITY FOR ANY OR ALL CONSTRUCTION DEFICIENCIES. 5. THE GENERAL CONTRACTOR SHALL HOLD HARMLESS, INDEMNIFY AND DEFEND THE ARCHITECT. FROM ANY ACTION INITIATED BY THE OWNER OR ANY SUBSEQUENT OWNERS FOR CONSTRUCTION DECIENCIES, MODIFICATIONS OR SUCH CONDITIONS WHICH MAY BE BEYOND THE CONTROL OF THE ARCHITECT. FROM ANY CORSEN DUE TO THE CONTRACTOR ANY SUBSEQUENT OWNERS FOR CONSTRUCTION AND AGENERAL CONTRAC	 PROJECT REPORTS / STUDY(S) / ASSESSMENT / OUT REACH NOISE STUDY - PROJECT SHALL COMPLY WITH A NOISE STATEMENT OR STUDY PREPARED BY A QUALIFIED PROFESSIONAL THAT ADDRESSES THE NECESSARY MEASURES TO LOWER DECIDEL LEVELS TO RESIDENTIAL CITY STANDARDS AND WILL BE PUT INTO PLACE TO MITIGATE FOR THE NOISE FROM ADJACENT LEWELLING BLVD AND INTERSTATE 880. GEOTECHNICAL REPORT (ENG) - PROJECT SHALL SUBMIT FINAL GEOTECHNICAL REPORT FOR CITY REVIEW. MUNICIPAL REGIONAL STORMWATER PERMIT PROVISIONS (ENG) - PER PROVISION C.35 OF THE SAN FRANCISCO BAY REGION MUNICIPAL REGIONAL STORMWATER NPDES PERMIT (RDER NO. R.2015:0049, NPDES PERMIT NO. CASB12008, ADOPTED 119/2015, REGULATED PROJECTS SHALL PROVIDE THE FOLLOWING DOCUMENTATION AS PART OF THE PLANNING APPLICATION: CLEAN WATER PROGRAM - SUBMIT TO ENGINEERING & TRANSPORTATION A FILED-OUT PLANNING PERMIT SUBMITT D ENGINEERING & TRANSPORTATION (I.E., CATEGORICAL EXEMPTION, NEGATIVE DECLARATION, MITIGATED NEGATIVE DECLARATION) INCLUSIONARY HOUSING - UNDER THE INCLUSIONARY ZONING ORDINANCE, APPLICANT HAS THE OPTION TO PAY THE IN LIEU HOUSING FEE OR PROVIDE ONE MODERSTATE INCOMMENSING - UNDER THE INCLUSIONARY ZONING ORDINANCE, APPLICANT HAS THE OPTION TO PAY THE IN LIEU HOUSING FEE OR PROVIDE ONE MODERSTATE INCOMMENSING - LIANGE OR BAARA, WHICH ADMINISTERS THE CITY HOMEBUYER PROGRAMS CALCULATES THAT BAY AREA AFFORDABLE HOMEOWNERSHIP ALLANGE OR BAARA, WHICH ADMINISTERS THE CITY HOMEBUYER PROGRAMS CALCULATES THE CITY OF ROLLED OR FILMATE HOMEOWNERSHIP ALLANGE OR DARAA, WHICH ADMINISTERS THE CITY HOMEBUYER PROGRAMS CALCULATES THE CITY OF ROLLED ROT FERMITS. NEIGHBORHOO	ABBREVIATIONS A ABV ABOVE AC ASPHALT CONCRET AD AREA DRAIN ADDL ADDITIONAL AFF ABOVE FINISH FLOC ASPH ASPHALT B BITUM BITUM BITUMINOUS BKG BACKING BLDG BUILDING BR BACKER ROD BUR BUIL TUP-ROOF BDR BEDROOM BW BOTTOM OF WALL C C C CACH BASIN CB CATCH BASIN CB CATCH BASIN CB CATCH BASIN CF CUBIC FEET CJ CONTROL JOINT CL COSET CARPET CONC CONC CONCRETE CPT CARPET D DECK DR DRAIN DU DWELLING UNIT E ELECTRICAL EP ELECTRICAL	GC GENERAL CONTRAC GL GLASS GND GROUND GWB GYPSUM WALL BOAF GYP GYSUM H HOBD HARDBOARD HDR HEADER HDWR HARDWARE HOWR HARDWARE HOWR HARDWARE HOWR HARDWARE HOWR HARDWARE HARDWARE HEATER HARDWARE HARDWARE HEATER HARDWARE HEATER HARDWARE HARDWARE HEATER HARDWARE HARDWARE HAR	NOM NOMINAL NP NO PARKING NR NON-RATED NTS NOT TO SCALE O O OA OVERALL OC ON CENTER OD OUTSIDE DIAMETER/ DIMENSION OFCI OWNER FURNISHED CONTRACTOR OFOI INSTALLED	S SCD SEE CIVIL DRAWINGS SCHD SCHEDULE SD STORM DRAIN SECT SECTION SED SEE ELECTRICAL DRAWINGS SF SQUARE FOOT OR FEET SHR SHOWER SHT SHEET SHT SHEET ST SELANDSCAPE DRAWINGS SOF SOFFIT SOG SLAB ON GRADE SPD SEE FLUMBING DRAWINGS SOF SOFFIT SO SLAB ON GRADE SPD SEE FLUMBING DRAWINGS STC SOUND TRANSMISSION STD COEFFICIENT ST STAUCTURAL SQUARE YARD T T T& T& T& T& T& T& T& T&	
 OWNERSHIP OF DRAWINGS: THESE DRAWINGS ARE THE PROPERTY OF GKW ARCHITECTS.INC GORDON WONG, ARCHITECT, THE DRAWINGS SHALL NOT BE USED FOR ANY OTHER PURPOSE EXCEPT AS APPROVED BY THE ARCHITECT. LIMITATION OF THE WORK: THE LIMITS OF THE WORK ARE ESTABLISHED BY 	GRAPHIC SYMBOLS	FURR FURRING				
THE DRAWINGS. THE CONTRACTOR SHALL BE RESPONSIBLE FOR COORDINATING TRADESMEN WITH THESE LIMITS.	ASPHAULT CONCRETE BUILDING SECTION L	- WINDOW TYPE		CHECK VALVE,SD-201	CLEAN OUT BOX,SD-313	Project Scher
		- WINDUW TYPE	TO FH	FIRE SERVICE,SD-204 SFS	BACK FLOW PREVENTOR SD-314	No. Date 2018.08.08
		, ,				2019.01.07
		CATCH BASIN	CB III OR	IRRIGATION WATER SERVICEO		2019.07.11
	RIGID INSULATION KEYNOTE ?	STORM DRAIN PERFORM	ATED TUBEO	DOMESTIC WATER METERS		Project Ger
	DEIMO EX. PARTS REVISION	APPROXIMATE LINE OF	WORK	IRRIGATION WATER METER, SD-202		
	HRE ACCESS ROOM TAGS [100]	REMOVE	\otimes	SANITARY SEWER MANHOLE		G0 SCALE 1/ 7/10/2019

EXHIBIT C - PROPOSED SITE PLAN

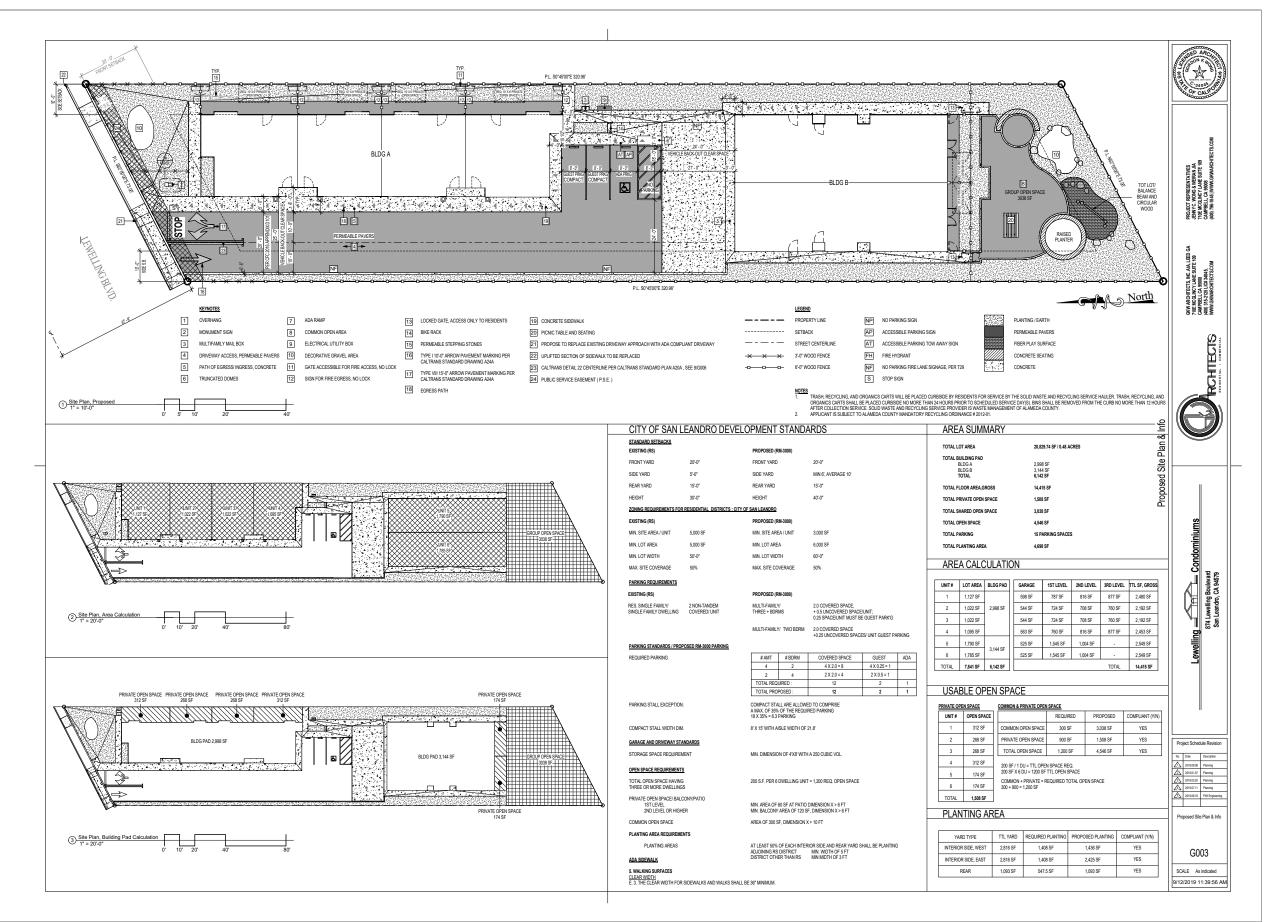


EXHIBIT D - STREETSCAPE


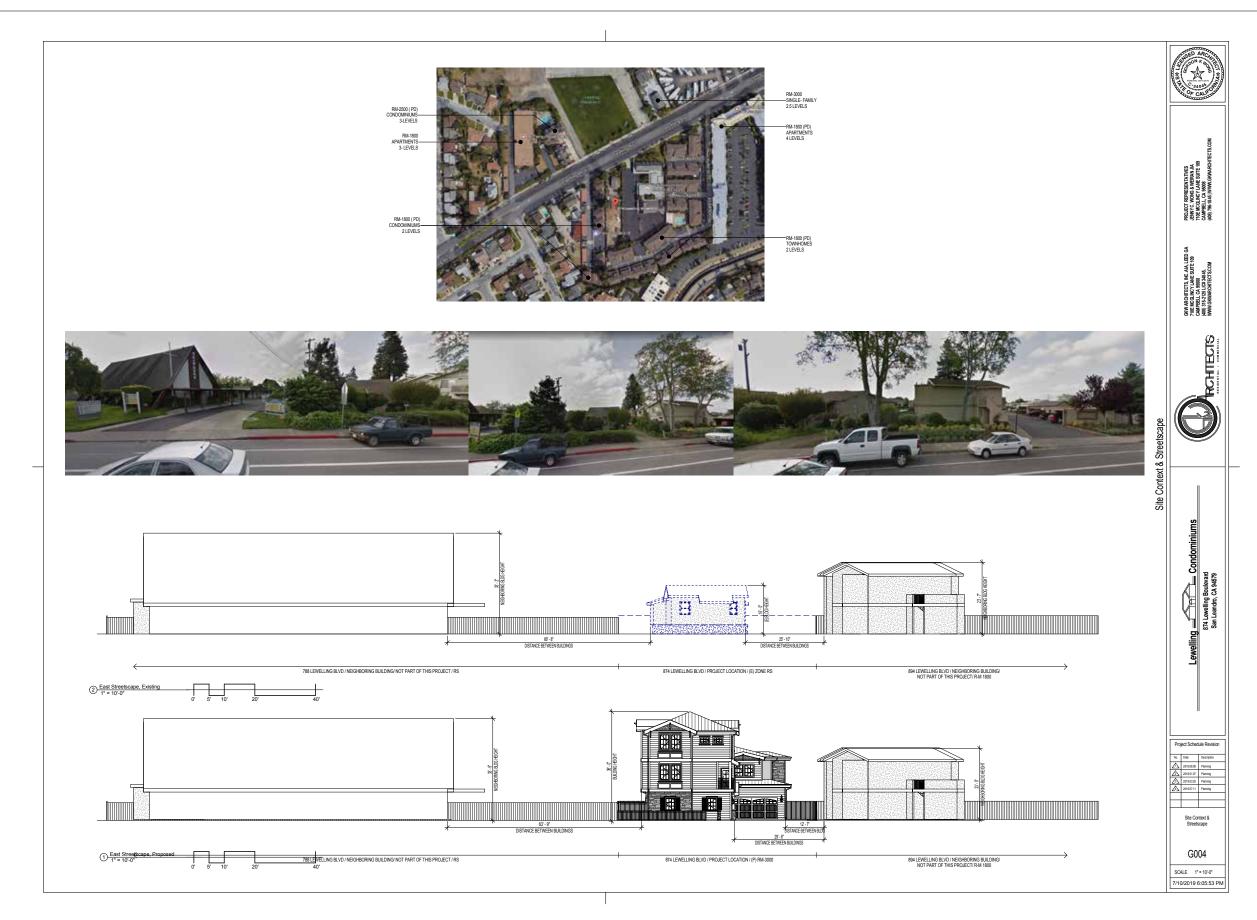


EXHIBIT E - DEMOLITION PLAN

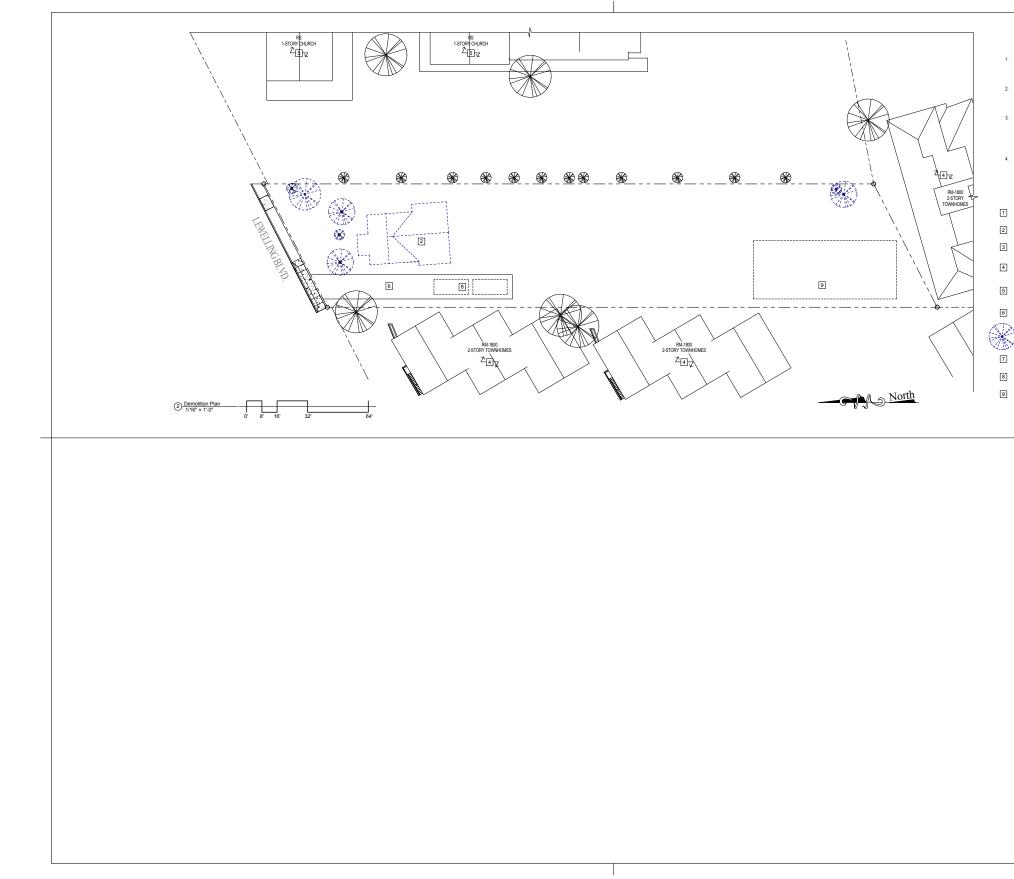

DEMOLITION PLAN NOTES PRICE TO GRADING, STRUCTURES AND THEIR CONTENTS SHALL BE REVICE DO EDRUCISHED UNDER PERMIT IN AN ENVIRONMENTALLY SENSITIVE MANNER, PROPER EVALUTATION, NALVISIS AND DESIGNAL OF INTERNAL SHALL BE DONE BY APPROPRIATE PROFESSIONALIS) TO MITCATE HAZAROS. ALL SUBLEAPRO-STRUCTURES SHALL BE ROAMVED PROPERTY IN GOERNATION TO INSE THEAT TO THE DESIGNMENT BY THE STRUCTURES SHALL BE ROAMVED PROFERITY IN GOERNMENT UNDER THEATURE TO THE DESIGNMENT ENVIRONMENT THESE STRUCTURES SHALL BE DOOLNENTED AND REMOVED UNDER FREMIT WHEN REQUIRED. THE SANLEARNOR FILE BEART THEORY SHALE DOOLNENTED	Noos
OFFICE SHALL BE NOTIFIED MMEDIATELY IF HAZARDUIS MATERIALS OR ASSOCIATES STRUCTURES ARE DISCOVERED DURING DEMOLTION DURING GRADING. THESE STRUCTURES SHALL INCLUE, BUT SHALL NOT BE LIMITED TO. ACTUAL HAZARDOUS MATERIALS, LINDERGRAUND TAKIS, GR OTHER VESSES THAT MAY HAVE CONTAINED HAZARDOUS MATERIALS. FIRE HYDRAMTS AND FIRE LAKES FOR THE DEVIGO/MENT SHALL BE OPERATIONAL AND I SERVICE PRIOT THE DEVIGO/MENT SHALL DE OPERATIONAL AND I SERVICE PRIOT THE DEVIGO/MENT SHALL DE OPERATIONAL AND I SERVICE PRIOT TO THE STRAT OF ANY COMBUSTBLE CONSTRUCTION AND IOR STORAGE OF COMBUSTBLE CONSTRUCTION MATERIALS.	PROJECT REPRESENTATIVES LENYC LONG X MERIOL AL LENYC LONG X MERIOL AL CAMPELL (J. 1800 1995-184 (IWW) GMMARCHITECTS CO (403) 756-184 (IWW) GMMARCHITECTS CO
DEMOLITION PLAN, KEYNOTES	
(E) DRIVEWAY (E) RESIDENCE TO BE DEMOLISHED (E) SHED TO BE DEMOLISHED (E) SURROLINDING 2.5TORY TOWNHOMES, ZONE RM-100, NOT PART OF THIS PROJECT (E) SURROLINDING 1 STORY CHURCH, ZONE RS,	GKV ARCHITECTS, MIC, AAL LEED GA THEE LOSANC VANE STATE A 1990 STATE LICE 39 405, 403 STATE LICE 39 405, 403 STATE STOCOM
NOT PART OF THIS PROJECT	
(E) GRAVEL DRIVEWAY TO BE RENOVATED	
(E) TREE TO BE REMOVED	
CONSTRUCTION HOURS: AM TO PM	
CONSTRUCTION STAGING	
	Demolition Plan & Notes
	G005 SCALE 1/16" = 1'-0" 7/10/2019 6:05:55 PM

EXHIBIT F - FIRE ACCESS

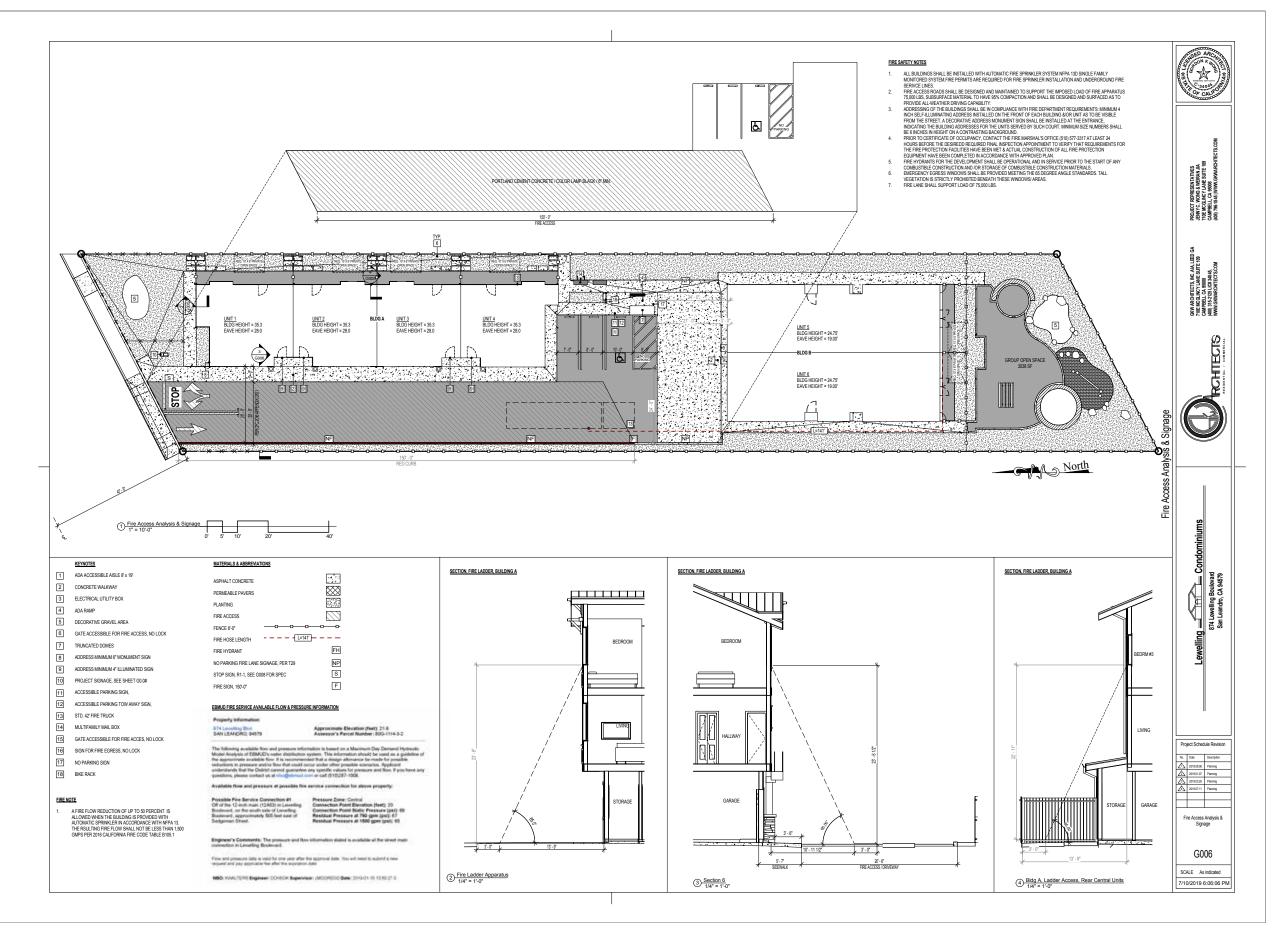


EXHIBIT G.1 - BUILDING A FLOORS 1 AND 2

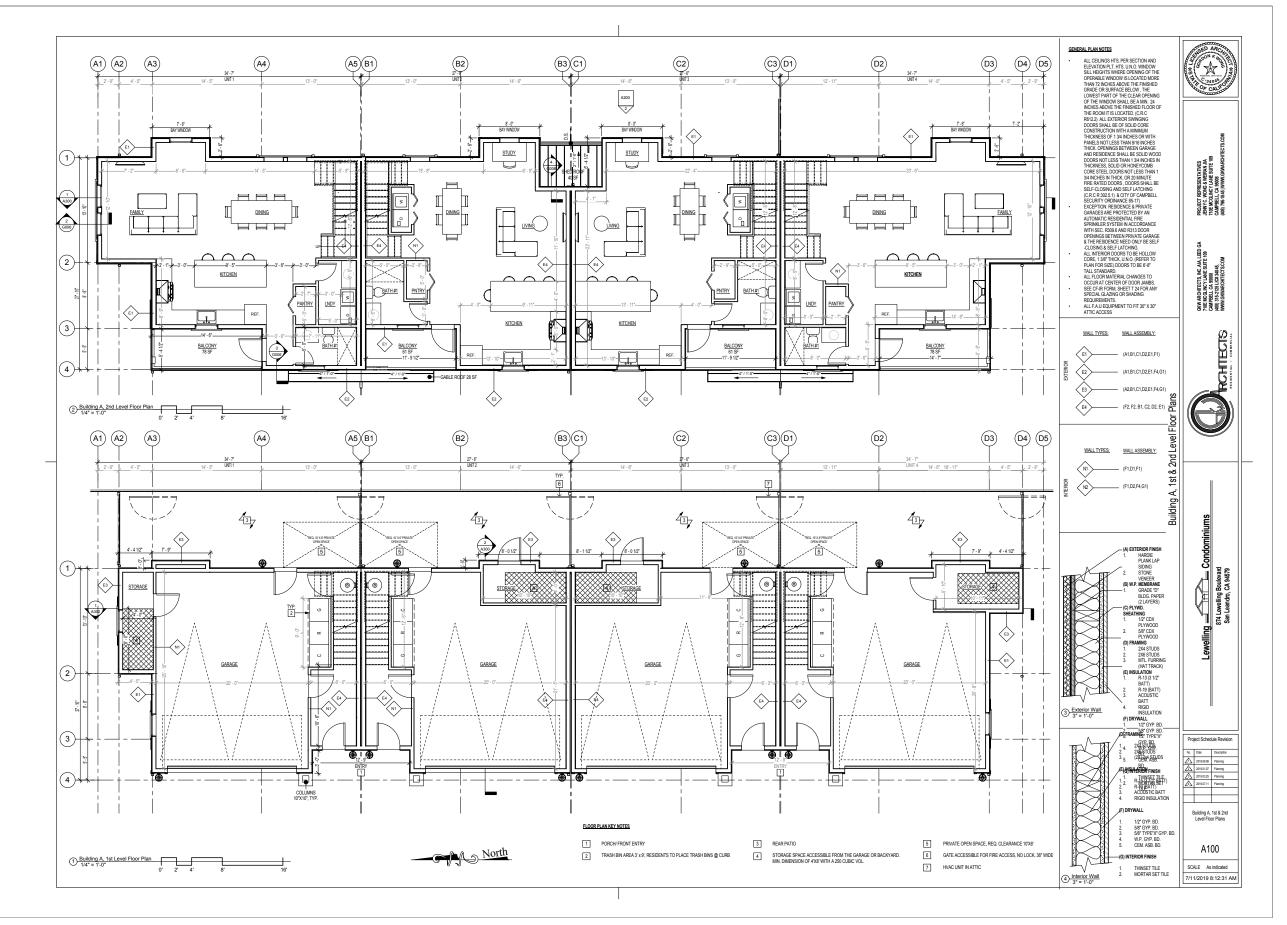


EXHIBIT G.2 - BUILDING A FLOOR 3 AND ROOF

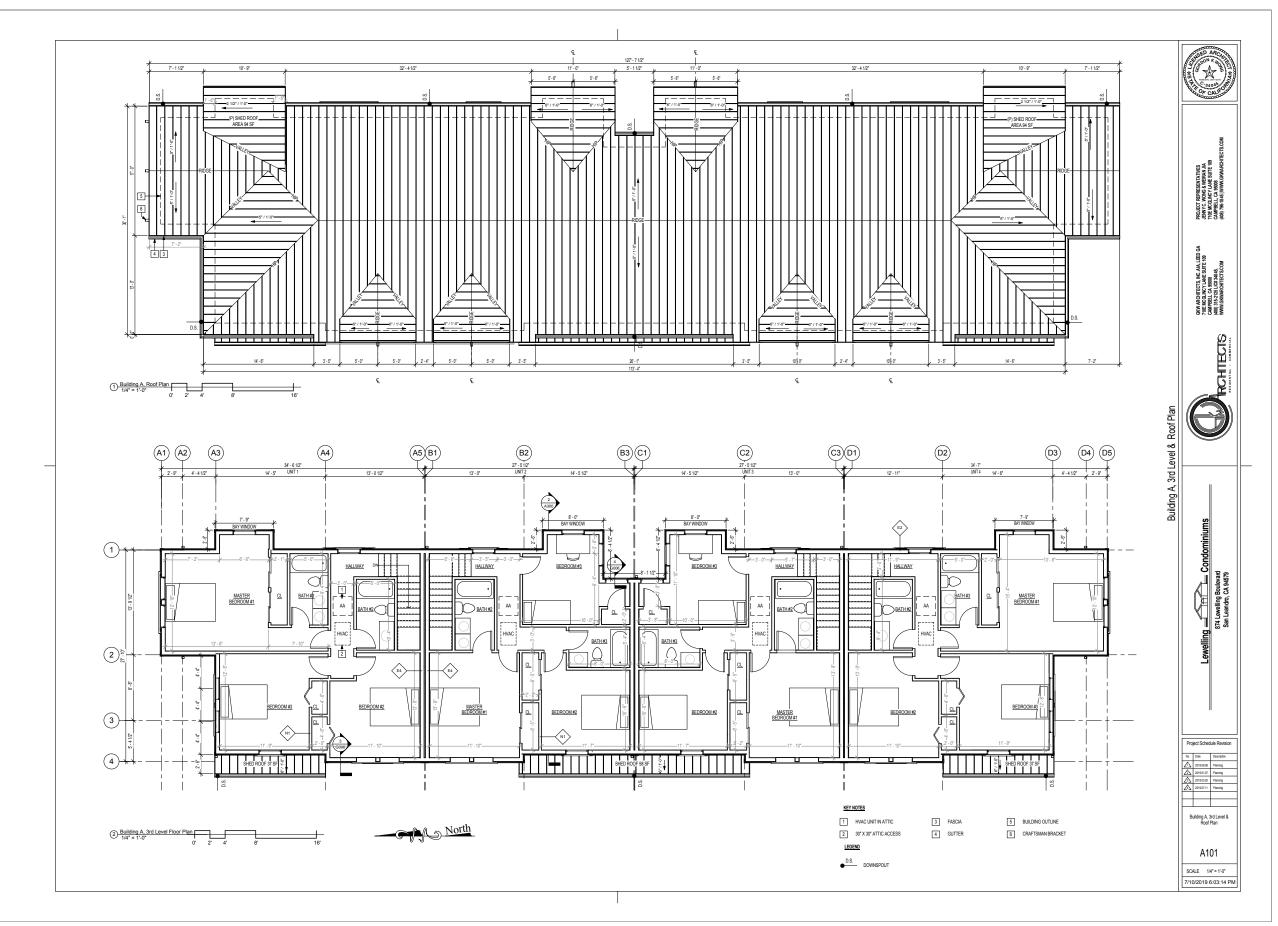


EXHIBIT G.3 - BUILDING B FLOORS 1 AND 2

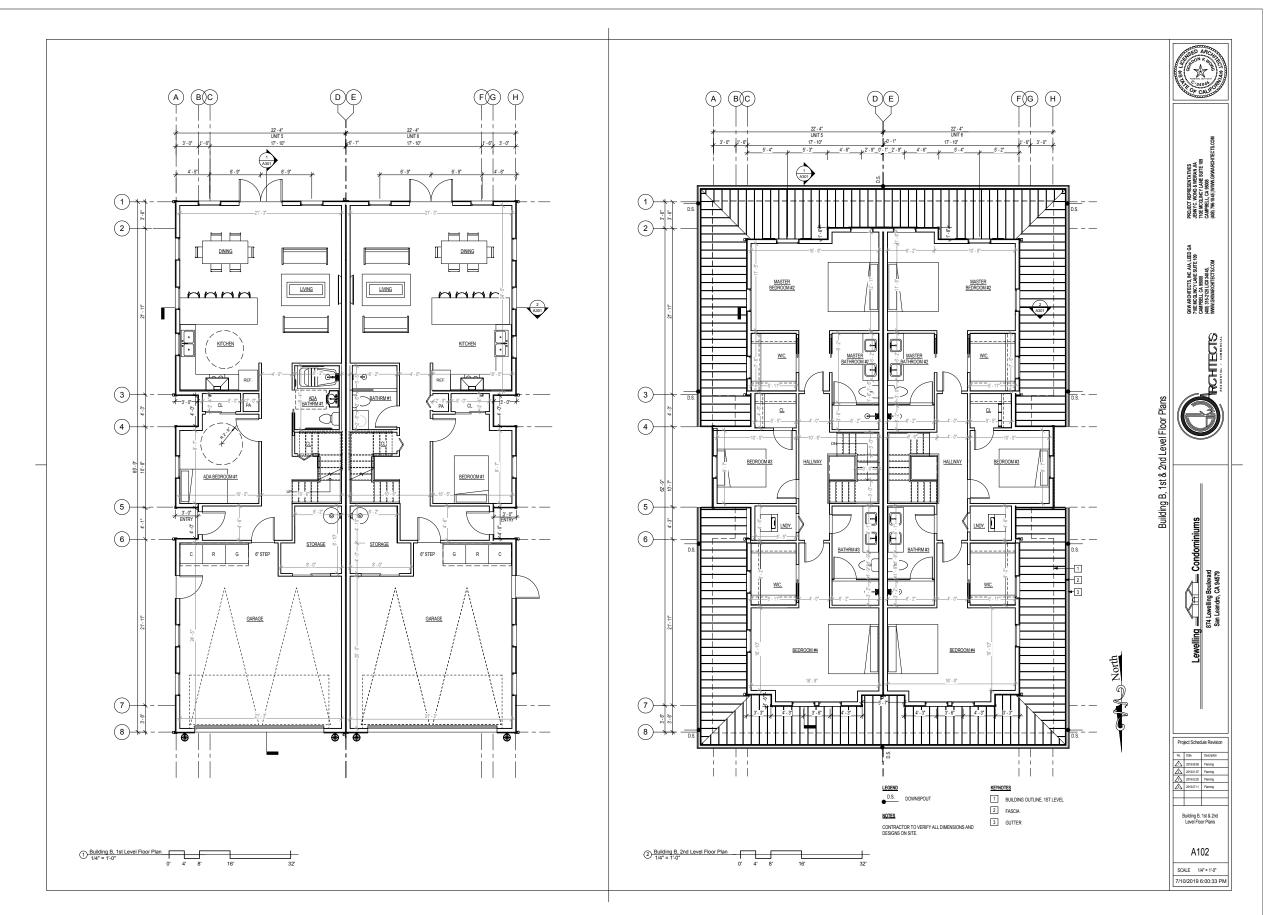


EXHIBIT G.4 - BUILDING B ROOF

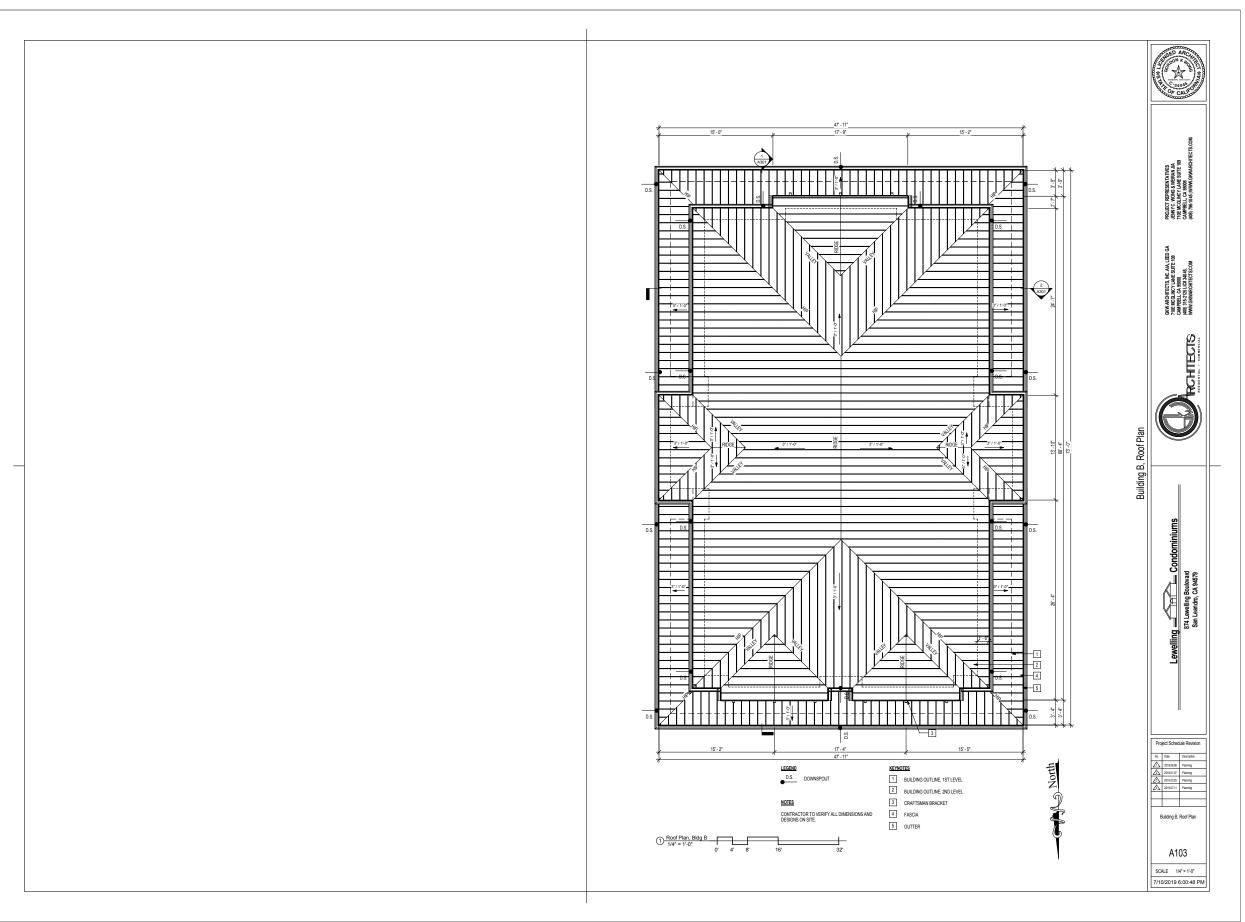


EXHIBIT H.1 - BUILDING A ELEVATION



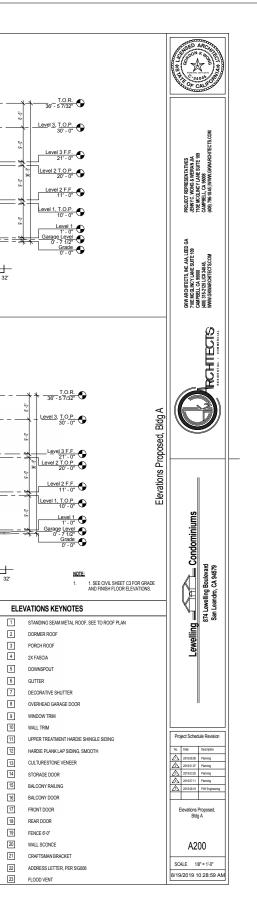


EXHIBIT H.2 - BUILDING B ELEVATION



EXHIBIT I.1 - BUILDING A CROSS-SECTION

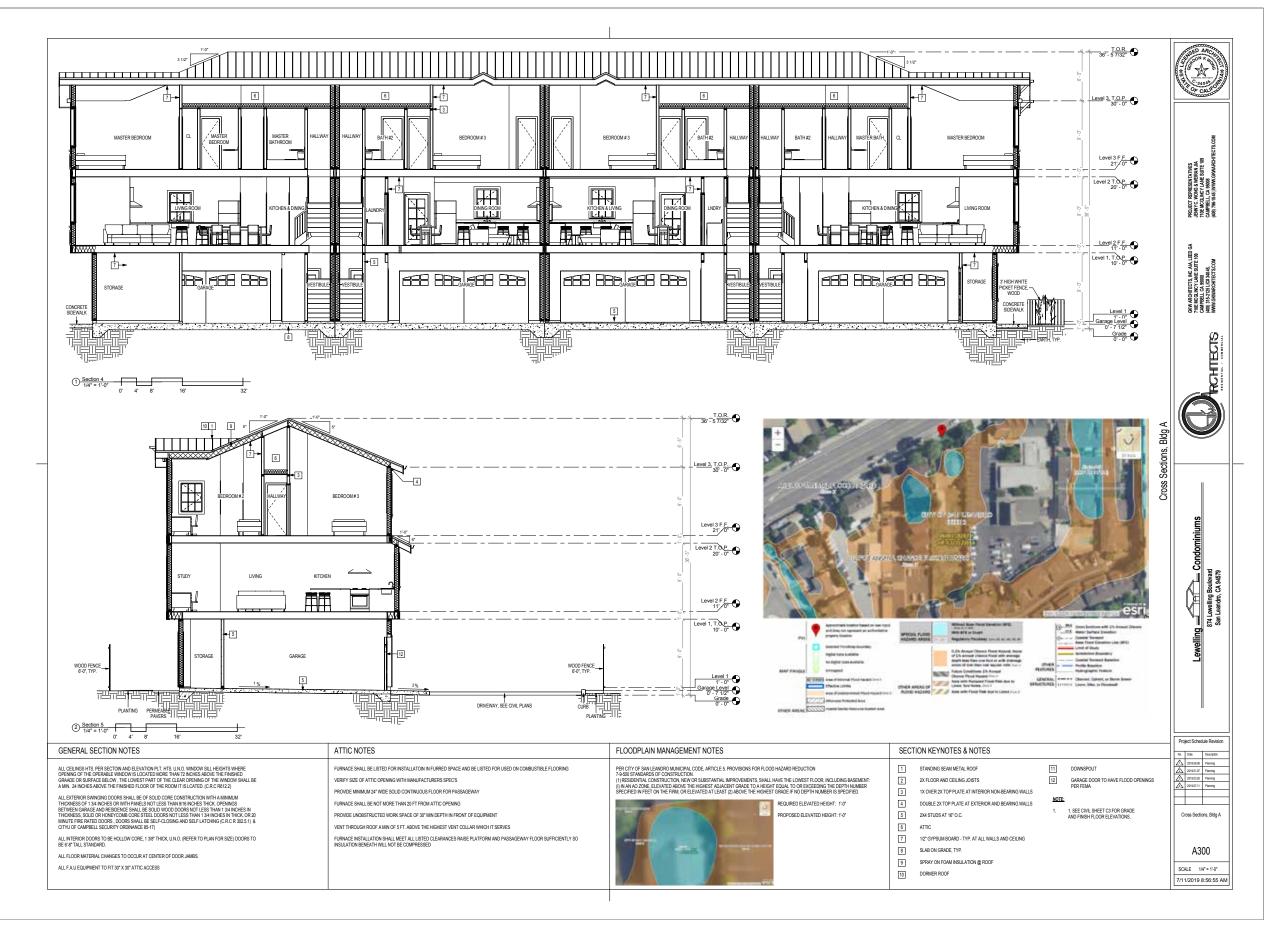
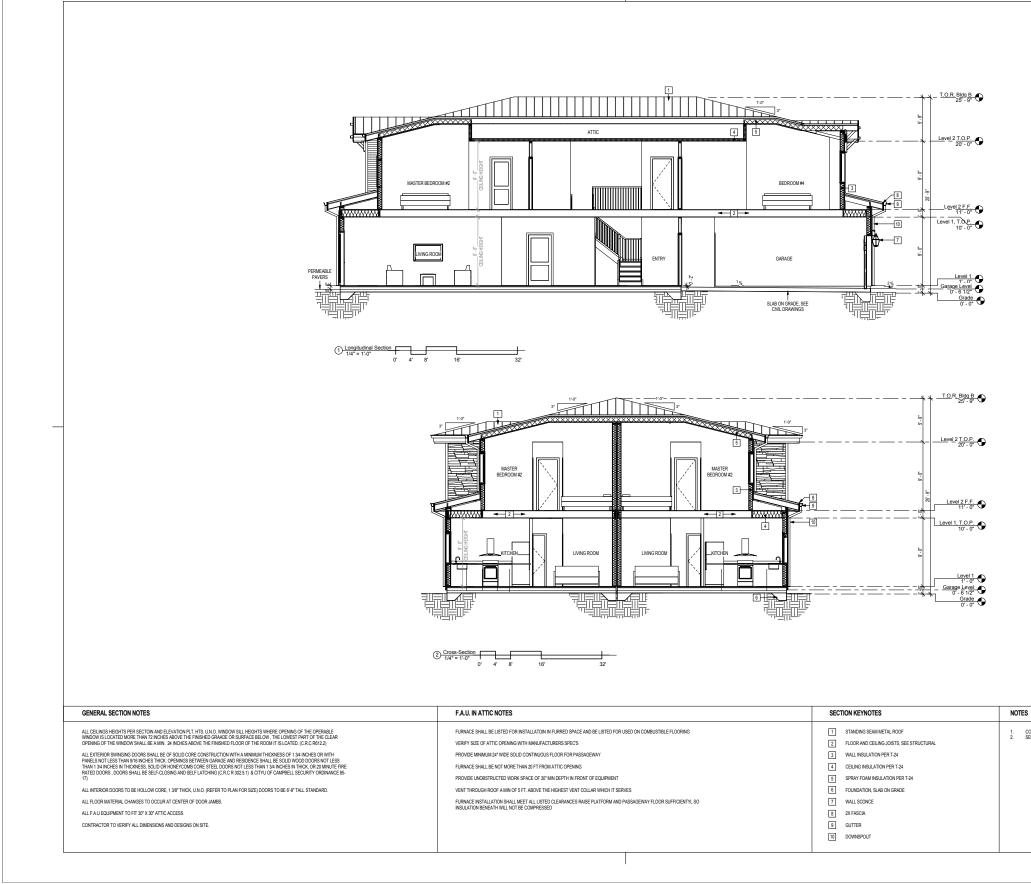


EXHIBIT I.2 - BUILDING B CROSS-SECTION




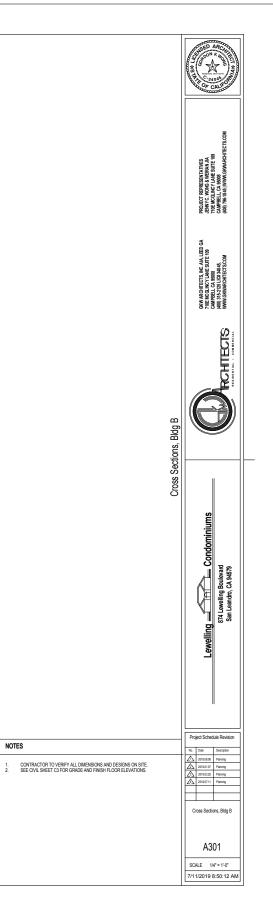


EXHIBIT J - COLOR AND MATERIAL BOARD

COLOR & MATERIAL BOARD | LEWELLING CONDOMINIUMS 874 LEWELLING BOULEVARD SAN LEANDRO, CA 94579

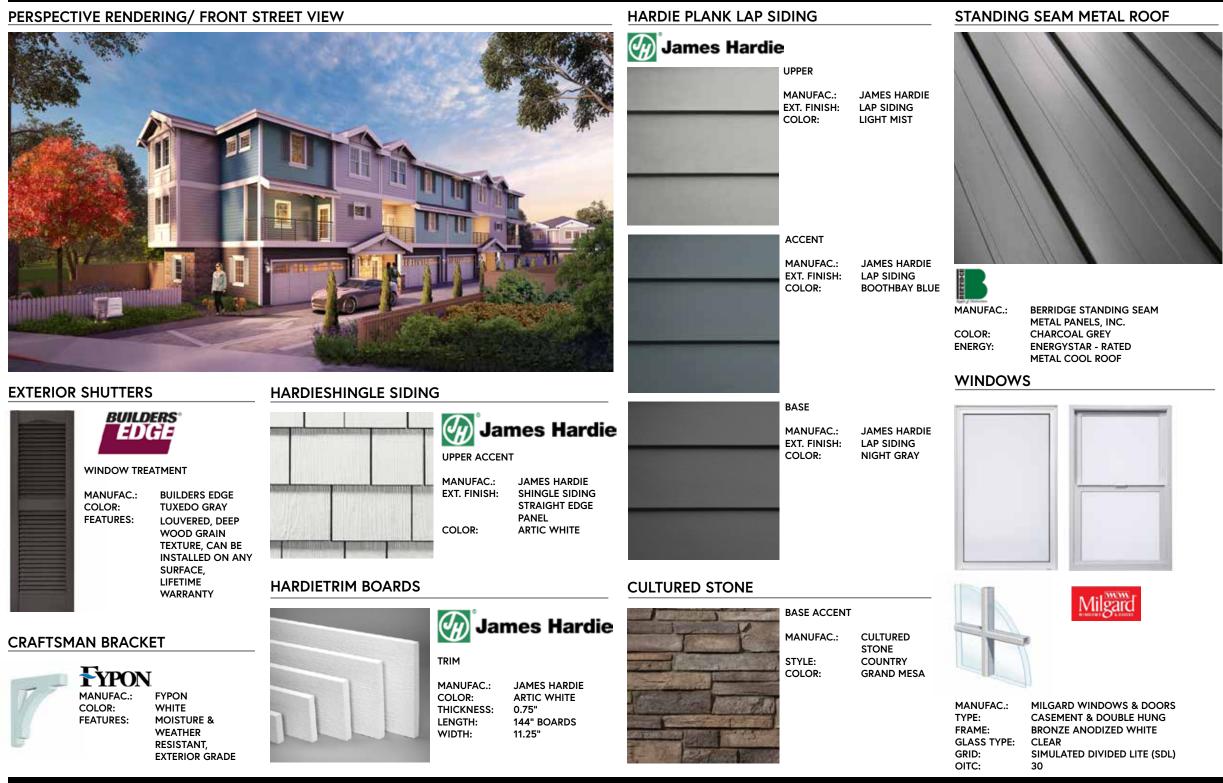

A500

EXHIBIT K - SIGNAGE



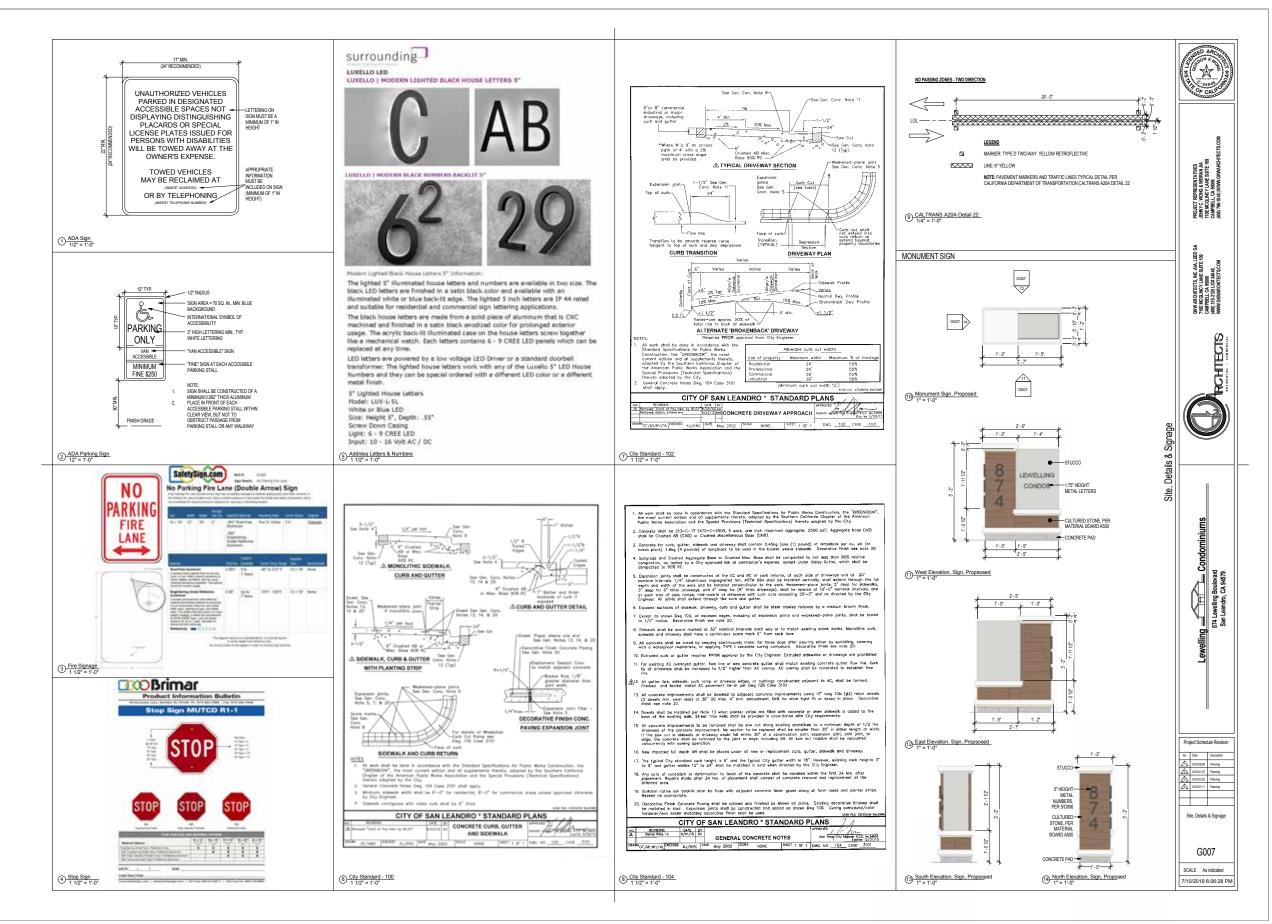


EXHIBIT L - TENTATIVE TRACT MAP 8542

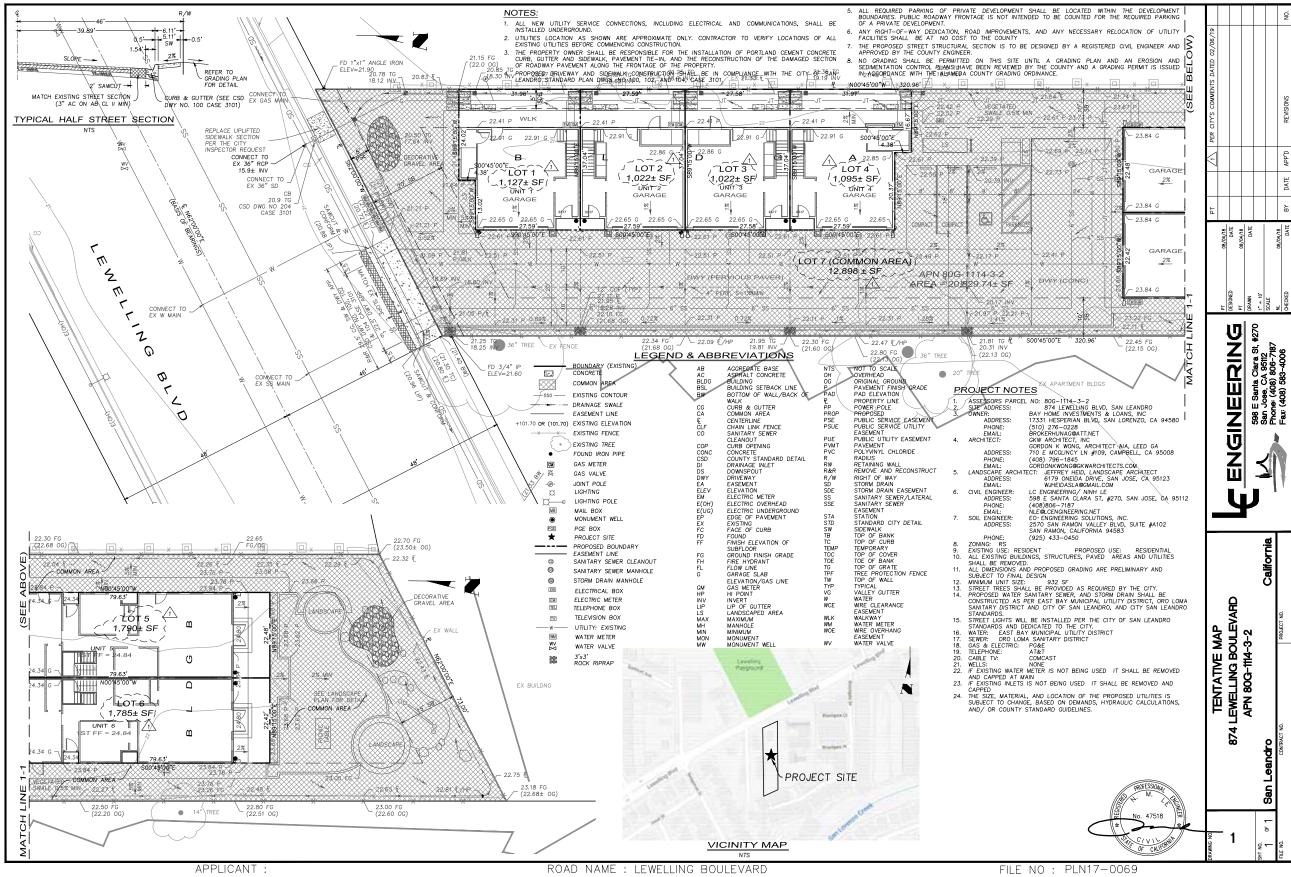

PLN17-0069 874 Lewelling Blvd - 6-Unit Townhome Development- Zoning Amendment, Planned Development, Site Plan Review, Tentative Map

EXHIBIT M - BOUNDARY SURVEY AND TOPOGRAPHIC MAP

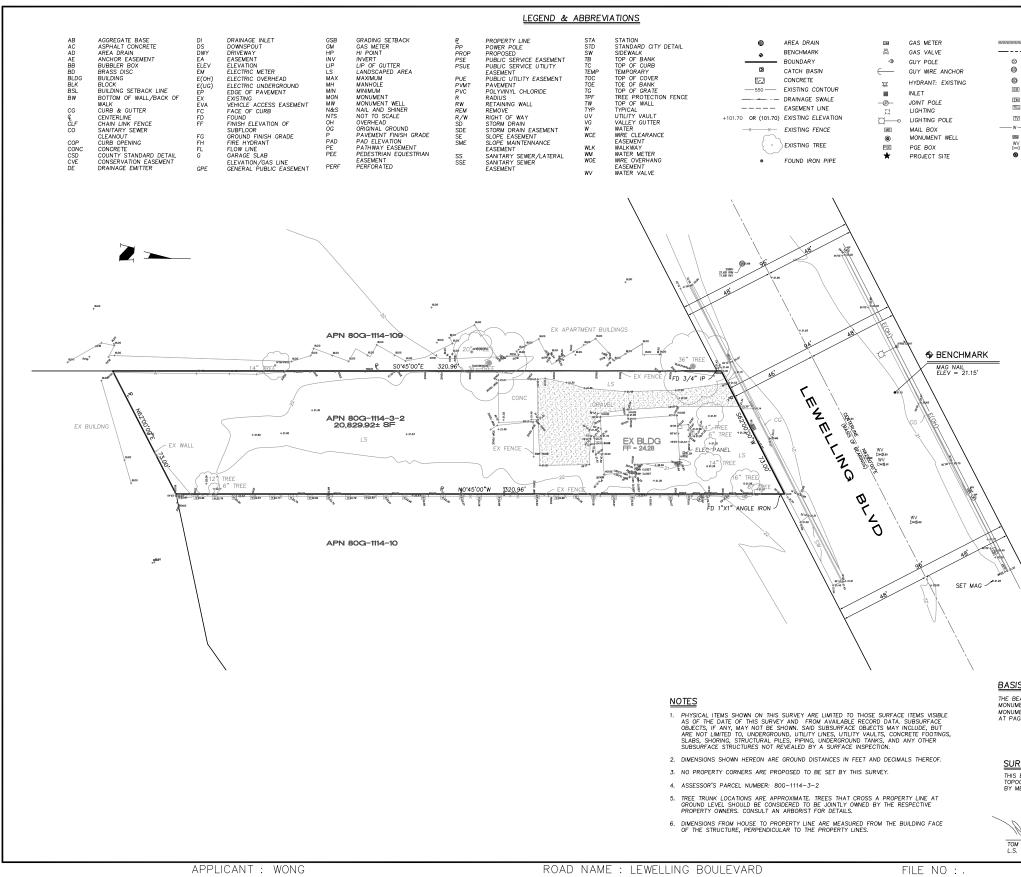


							NO.
RIGHT OF WAY SANITARY SEWER CLEAN OUT MANHOLE SANITARY SEWER MANHOLE SANITARY SEWER MANHOLE SIGRM DRAIN MANHOLE ELECTRICAL BOX ELECTRICAL BOX ELECTRIC METER ELEVISION BOX UTUTY: EXISTING WATER METER WATER VALVE WELL							DATE APP'D REVISIONS
							ВΥ
		PT 06/29/18	GNED DATE 06./29./18	DRAWN DATE	1" = 20"	SCALE SCALE	CHECKED DATE
				Eve E Secto Class & 4070		Phone: (408) 806-7187	Fax: (408) 583-4006
			ILEVARD	Ņ			PROJECT NO.
S OF BEARINGS EARINGS SHOWN ON THIS MAP ARE BASED ON THE HENT LINE ON LEWELLING BOULEVARD, AS FOUND HENTED AS NE2'00'00'E RECORDED IN BOOKS BO OF MAPS, GE 26, ALAMEDA COUNTY RECORDS.			874 LEWELLING BOULEVARD	APN 80G-1114-3-2		san Leandro	CONTRACT NO.
M H. MILO 6438 DATE 06/29/18	DRAMNG NO.	Т	-1		کر ک		NO.

EXHIBIT N - OVERALL SITE PLAN


GRADING AND DRAINAGE IMPROVEMENTS		LEG	END & ABBREVIATIONS			
GENERAL NOTES: GENERAL NOTES: ALL CONSTRUCTION WORK SHALL BE PERFORMED IN ACCORDANCE WITH THE SOILS AND/OR GEOTECHNICAL REPORT PREPARED BY: A	AB AGOREGATE BASE AC ASPHALT CONCRETE AD AREA DRAIN AE ANCHOR EASEMENT AP APROACH BB BUBBLER BOX BD BULDING BLM BLOCK BLDG BULDING BLW BLOCK BLDG BULDING BLW BLOCK BLDG BULDING BLW BLOCK BLDG BULDING BLW BLOCK BULDING BETBACK LINE BW BOTTOM OF WALL/BACK OF WALK CG CURB & GUTTER Q CENTERLINE CG CURB & GUTTER Q CENTERLINE CG CURB & GUTTER CG CG CG CA CA CURB & GUTTER CG CG CG CA CA CURB & GUTTER CG	FG GROUND FINISH GRADE FH FIRE HYDRANT FL FILCOW LINE G GARAGE SLAB ELEVATION/CAS LINE GEVERAL PUBLIC EASEMENT GSB GRADING SETBACK GM GAS METER HP HI POINT INV INVERT LIP LIP OF GUTTER LIP LIP OF GUTTER LIP LIP OF GUTTER LIP LIP OF GUTTER LIP LIP OF GUTTER MAX MAXIMUM MH MANHOLE MAX MAXIMUM MH MONUMENT WELL NASS NAL AND SHINER NTS NOT TO SCALE OH OVERHEAD OG ORIGINAL GROUND P PAVEMENT FINISH GRADE PAD PAD ELEVATION PE PATHWAY EASEMENT PEE PEDESTRIAN EQUESTRIAN EASEMENT PEE PUBLIC SERVICE EASEMENT PSUE PUBLIC SERVICE LASEMENT PVC PACHIMIN CHLORIDE (SCHEDULE 40)	R RADIUS RW RETAINING WALL REM REMOVE R/W RIGHT OF WAY SD STORM DRAIN EASEMENT SDE STORM DRAIN EASEMENT SE SLOPE FASEMENT SME SLOPE CASEMENT SS SANITARY SEWER/LATERA	AREA DRAIN AREA DRAIN BENCHMARK BENCHMARK GB CATCH BASIN EZ CONCRETE CONCRETE DRAINAGE SWALE ASSEMENT LIVE	EIII ELECTRICAL BOX EIII ELECTRIC METER TELEPIONE BOX TELEVISION BOX W UTILITY: EXISTING W UTILITY: EXISTING W UTILITY: EXISTING W UTILITY: EXISTING W WATER METER B 3'x3' ROCK RIPRAP DOWNSPOUT WITH SPLASH BLOCK G BASIS OF BEL	
FACILITY VIA DOWNSPOUTS, PAVEMENT AND COLLECTON PIPES THAT DISCHARGE DIRECTLY TO THE STORM DRAIN SYSTEM. 8. EROSION CONTROL PLANTING AND OTHER SILT RETENTION OR EROSION CONTROL MEASURES MAY BE REQUIRED IN ALL GRADED AREAS. SEE LANDSCAPE PLAN, IF APPLICABLE, FOR DETAILS OF PLANTING. 9. DRAINAGE, INCLUDING ALL ROOD AND DATIO DRAINS, SHALL BE DIRECTED AWAY FROM THE STRUCTURE, IT SHALL BE THE OWNER'S AND CONTRACTOR'S RESPONSIBILITY TO ENSURE THAT THE DRAINAGE SYSTEM FACILITES SHOWN HERFON APE KEPT CLEAR OF OBSTRUCTIONS AND THE CONTRACTOR SHALL PROVIDE UNDERGROUND PIPES AND REGRADE AREAS THAT WILL NOT DRAIN AFTER FINAL GRADING. THE GROUND ADJACENT TO THE BUILDING SHALL SLOPE AWAY WITH A MINIMUM SLOPE OF 1%. 10. THE PERMITTEE SHALL MAITAIN THE STREETS, SIDEWALKS AND ALL OTHER PUBLIC. 10. THE PERMITTE SHALL MAITAIN THE STREETS, SIDEWALKS AND ALL OTHER PUBLICS ROCK OR CONSTRUCTION DERBIS SHALL BE REMOVED FROM THE PUBLICLY OWNED PROPERTY DURING CONSTRUCTION AND UPON COMPLETION OF THE PROJECT. ALL ADJACENT PROPERTY, PRIVATE OF PUBLIC, SHALL BE MAINTAINED IN A CLEAN, SAFE	BENCHMARK MAG NAL SET MAG SET MAG 86 96 96 96 96		1"x1" ANGLE IRON V=21.90		MONUMENT LINE ON L MONUMENTED AS N62 AT PAGE 26, ALAMED	LEWELING BOULEVARD, AS FOUND TOYOO'DE RECORDED IN BOOKS 80 A COUNTY RECORDS.
 AND USABLE CONDITION. 11. THIS PLAN DOES NOT APPROVE REMOVAL OF TREES. APPROPRIATE TREE REMOVAL PERMITS AND METHOD OF TREE PRESERVATION SHOULD BE OBTAINED FROM THE CITY. 12. THIS PLAN IS A PART OF PROJECT PLANS. SEE ARCHITECT AND LANDSCAPE PLANS, IF APPLICABLE, FOR DETAILS AND DIMENSIONS. FENCES AND WALLS ARE NOT A PART OF THESE PLANS. SEE ARCHITECT PLAN. 13. SOLL ENGINEER TO PROVIDE FINAL LETTER OF INSPECTION AT COMPLETION OF THE GRADING IN ACCORDANCE WITH THE ALAMEDA COUNTY GRADING ORDINANCE CHAPTER 15.36. 14. CONTRACTOR SHALL GRADE EVENLY BETWEEN SPOT ELEVATIONS SHOW. 					N00'45'00'W, 320,96', , , , , , , , , , , , , , , , , , ,	
 ALL WORK SHALL BE PERFORMED IN ACCORDANCE WITH APPLICABLE O.S.H.A. REGULATIONS. CONTRACTOR TO VERIFY ALL EXISTING INVERT ELEVATIONS FOR STORM DRAIN CONSTRUCTION PRIOR TO ANY SITE WORK. SHOULD DISCREPANCIES EXIST BETWEEN THE ACTUAL ELEVATIONS AND LOCATIONS OF EXISTING STORM DRAIN CONNECTIONS AND THOSE AS SHOWN ON THESE PLANS, THE CONTRACTOR SHALL NOTIFY ENGINEER OF WORK BEFORE ADJUSTING THE DESIGN. CONTRACTOR SHALL UNCOVER AND EXPOSE ALL EXISTING UTILITY, SEWER AND STORM DRAIN. UNES WHERE THEY ARE TO BE CROSSED ABOVE OR BELOW BY THE NEW FACILITY BEING CONSTRUCTED IN ORDER TO VERIFY THE GRADE AND TO ASSURE THAT THERE IS SUFFICIENT CLEARANCE. HE OR SHE SHALL CALL THE ENGINEER OF WORK 		Provide the second seco				
REGARDING POTENTIAL CONFLICTS BEFORE FIELD WORK BEGINS. 18. APPROVAL OF THIS PLAN APPLIES ONLY TO THE EXCAVATION, PLACEMENT AND COMPACTION OF NATURAL EARTH MATERIALS. THIS APPROVAL DOES NOT CONFER ANY RIGHTS OF NATURAL EARTH MATERIALS. THIS APPROVAL DOES NOT CONFER ANY RIGHTS OF NATURAL CENTHER PUBLIC PROPERTY OR THE PRIVATE PROPERTY OF OTHERS. APPROVAL OF THIS PLAN ALSO DOES NOT CONSTITUTE APPROVAL OF ANY IMPROVEMENTS. PROPOSED IMPROVEMENTS ARE SUBJECT TO REVEW AND APPROVAL BY THE RESPONSIBLE AUTHORITIES AND ALL OTHER REQUIRED PERMITS SHALL BE OBTAINED. 19. ALL KNOWN WELL LOCATIONS ON THE SITE HAVE BEEN INCLUDED AND SUCH WELLS			FD 3/4" IP ELEV=21.60	PROJECT NOTES	201 TREE EX APARTMENT	ELDGS EARTH CUT = _88 C
SHALL BE MAINTAINED OR ABANDONED ACCORDING TO CURRENT REGULATIONS ADMINISTERED BY THE ALAMEDA VALLEY WATER DISTRICT. CALL (408) 265–2800 EXTENSION 382 TO ARRANGE FOR DISTRICT OBSERVATIONS OF ALL WELL ABANDONMENTS. 20. EARTHWORK QUANTITIES SHOWN ON THESE PLANS ARE ONLY TO BE USED TO DETERMINE THE AMOUNT OF THE GRADING PERMIT. 21. ADJUSTMENTS TO BUILDING PAD ELEVATIONS OR PARKING LOT GRADES TO ACHIEVE EARTHWORK BALANCE SHALL BE MADE ONLY WITH APPROVAL OF THE ENGINEER. 20. CONTRACTOR OR ANY SUBCONTRACTORS OF THE CONTRACTOR OR SUBCONTRACTOR'S WORKMEN'S ACCOMPLISHMENT OF WORK ON THE PROJECT. CONTRACTOR WILL BE SOLELY AND COMPLETELY RESPONSIBLE FOR WORKING SONDITIONS ON THE JOB SITE.				ADDRESS: PHONE: EMAIL: 4. ARCHITECT: ADDRESS: PHONE:	874 LEWELLING BLVD, SAN LEANDRO BAY HOME INVESTMENTS & LOANS, INC 17331 HESPERIAN BLVD, SAN LORENZO, CA 94580 (510) 276-0228 BROKERHUNAG@ATT.NET SKW ARCHITECT, INC SORDON K WONG, ARCHITECT AIA, LEED GA 5070 K WONG, ARCHITECT AIA, LEED GA 710 E MCGLINCY LN #109, CAMPBELL, CA 95008 (408) 796-1845	FILL = <u>221C</u> IMPORT <u>133</u> EXPORT <u>0</u> EARTHWOOK OL FOR INFORMATI HIS/HER OWN IN PURPOSE.
INCLUDING SAFETY OF ALL PERSONS AND PROPERTY DURING PERFORMANCE OF THE WORK. THIS REQUIREMENT WILL APPLY CONTINUOUSLY AND NOT BE LIMITED TO NORMAL WORKING HOURS. 23. DURING THE PROGRESS OF THE WORK, THE CONTRACTOR SHALL KEEP THE PREMISES OCCUPIED BY HIM IN A NEAT AND CLEAN CONDITION, DISPOSING OF REFUSE IN A SATISFACTORY MANUER AS OFTEN AS DIRECTED, OR AS MAY BE NECESSARY SO THAT THERE SHALL AT NO TIME BE ANY UNSIGHTLY ACCUMULATION OF RUBBISH. 24. IF HUMAN REMAINS ARE DISCOVERED DURING THE CONSTRUCTION, UNLESS THE CORONER HAS NOTIFIED THE PERMITTEE IN WRITING THAT THE REMAINS DISCOVERED HAVE BEEN DETERMINED NOT TO BE NATIVE AMERICAN, NOTIFICATION LIST OF SUCH DISCOVERY. SUCH NOTIFICATION SHALL BE SET BY FIRST CLASS U.S. MAIL WITHIN SEVEN (7) DAYS OF THE DATE ON WHICH THE PERMITTEE NOTIFICATION LIST OF SUCH DISCOVERY. SUCH NOTIFICATION SHALL BE SEEN NOTIFIED IN ACCORDANCE WITH SHALL STATE THAT THE CORONER HAS BEEN NOTIFIED IN ACCORDANCE WITH	STREET GUTTER AT POINT OF DIS 12 INCHES (335 mm) PLUIS 2%, IT CAN BE DEMONSTRATED THAT STRUCTURE IS PROVIDED AT ALL 29. COMPLIANCE WITH THE LOCAL NO THE STORM DRAINAGE SYSTEM SH 30. ALL CONSTRUCTION SHALL COMPLI AND CHAPTERS 10 AND 11 OF TH	ON-POINT SOURCE ORDINANCE CONCERNING HALL BE THE RESPONSIBILITY OF THE GRAD LY WITH SECTION 24 OF THE STATE OF C. HE 2010 UNIFORM BUILDING CODE. IRAL SECTION IS TO BE DESIGNED BY A F	DRAINAGE DEVICE A MINIMUM OF TERNATE ELEVATIONS, PROVIDED ISCHARGE AND AWAY FROM THE G DISCHARGE OF MATERIALS TO ING CONTRACTOR. ALIFORNIA ADMINISTRATIVE CODE	EMAIL: 5. LANDSCAPE ARCHITE: ADDRESS: EMAIL: 6. CIVIL ENGINEER: ADDRESS: PHONE: EMAIL: 7. SOIL ENGINEER: ADDRESS:	CORDONKWONGOGKWARCHITECTS.COM CT: UEFREY HEID, LANDSCAPE ARCHITECT 6179 ONEDA DRIVE, SAN JOSE, CA 95123 WUHEIDASLA@GMAIL.COM LC ENGINEERING/ NINH LE 598 E SANTA CLARA ST, #270, SAN JOSE, CA 95112 (408)806-7187NG.NET EO-ENGINEERING SOLUTIONS, INC. 2570 SAN RAMON VALLEY BLVD, SUITE #A102 SAN RAMON, CALIFORNIA 94583 (925) 433-0450	SHEET INDE SHEET C1: OVERALL SHEET C2: IMPERVIC SHEET C3: GRADINC 2 SHEET C4: GRADINC SHEET C6: CROSS 3 SHEET C6: UTILITY SHEET C7: EROSION SHEET C8: EROSION SHEET C8: EROSION
CALIFORNIA STATE LAW. CONOCLE INS DELIVING CONTREL WITH CALIFORNIA STATE LAW. 25. NNY ABANDONED UNDERGROUND PIPES EXPOSED DURING CONSTRUCTION SHALL BE REMOVED, ADEQUATELY PLUGEOD, OR A COMBINATION OF BOTH IN ACCORDANCE WITH THE REDUREMENTS OF THE COUNTY. 26. THE CONTRACTOR SHALL BE RESPONSIBLE FOR THE LOCATION AND PROTECTION OF ALL UTILITES, FOR LOCATION OF UNDERGROUND UTILITIES, OR FOR EMERGENCY ASSISTANCE. CALL: UNDERGROUND SERVICE ALERT (USA) 800–642–2444 27. THE CONTRACTOR SHALL ADVSE THE OWNER OF APPROPRIATE MAINTENANCE PROCEDURES OF THE DRAINAGE SYSTEMS.	TWICE DAILY TO CONTROL DUST. AREAS OF DIGGING AND GRADING GRADING OR OTHER DUST-PRODUWHEN DUST IS READILY VISIBLE IN STOCKPILES OF SOIL, DEBRIS, S COVERED. 	SAND, OR OTHER DUST-PRODUCING MATE	TERED TO CONTROL DUST. DURING PERIODS OF HIGH WIND IRIALS SHALL BE WATERED OR	rion.		SHEET US: BEST MA

APPLICANT :

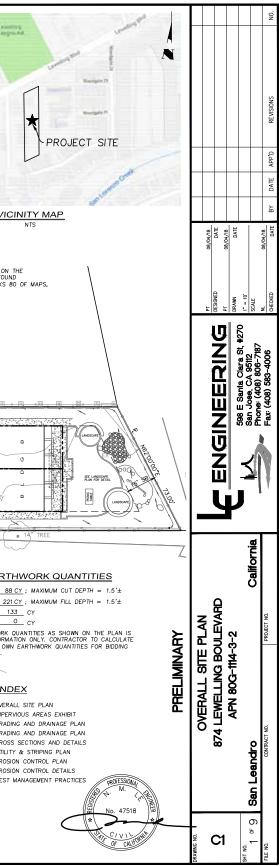

FILE NO : PLN17-0069

EXHIBIT O - IMPERVIOUS AREAS

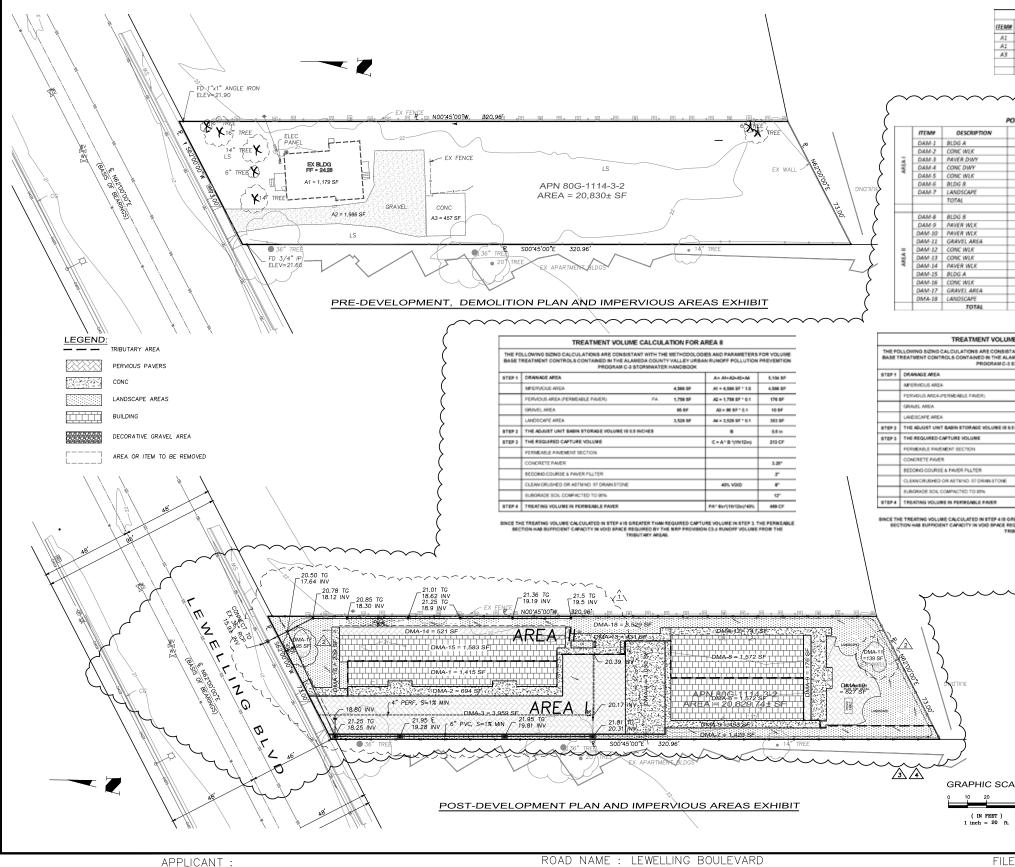


PLN17-0069 874 Lewelling Blvd - 6-Unit Townhome Development- Zoning Amendment, Planned Development, Site Plan Review, Tentative Map

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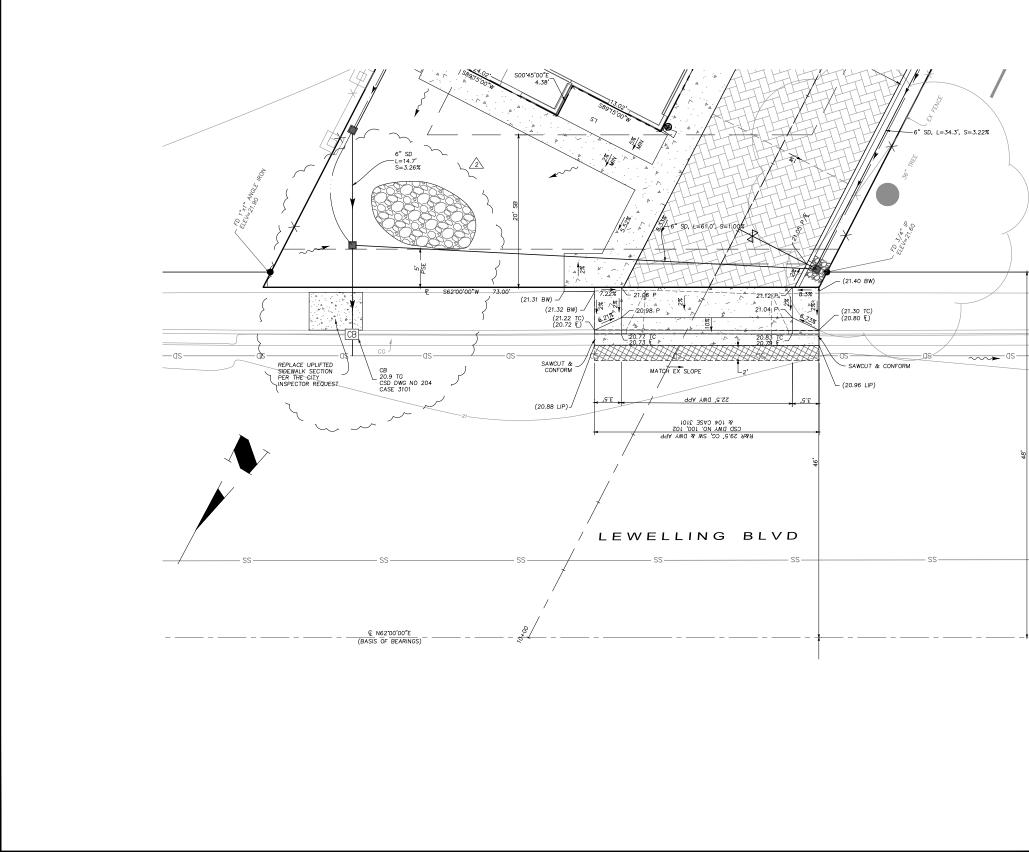
FILE NO : PLN17-0069

#### **EXHIBIT P.1 - GRADING AND DRAINAGE - SITE**

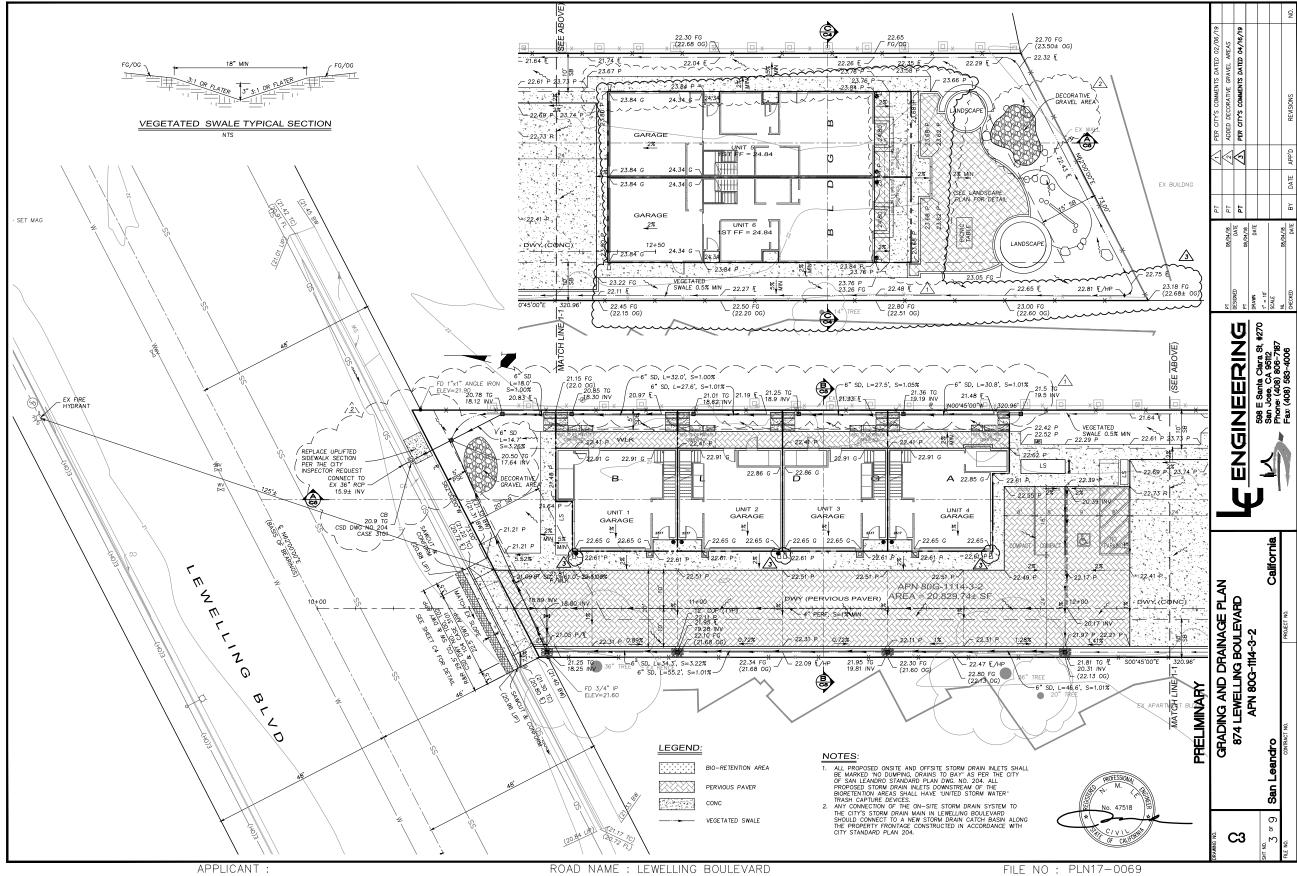


PLN17-0069 874 Lewelling Blvd - 6-Unit Townhome Development- Zoning Amendment, Planned Development, Site Plan Review, Tentative Map

#### **EXHIBIT P.2 - GRADING AND DRAINAGE - ROW CURB**



No. 47518 $\frac{1}{2}$	BRELIMINARY No. 47518			, 		A.			
DRAMING NO.	GRADING AND DRAINAGE PLAI	AGE PLAN		DT 00 /01 /00	2				
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	APN 80G-1114-3-2		598 E Santa Clara St. #270	DRAWN DATE 1* = 5'					
4 ° 9	San Leandro	California	Phone: (408) 806-7187	SCALE					
FILE NO.	CONTRACT NO.	PROJECT NO.	Fax: (408) 583-4006	CHECKED 08/04/18 DATE	ВΥ	DATE /	Q'99A	REVISIONS	NO.


# **EXHIBIT Q - CIVIL CROSS-SECTIONS**

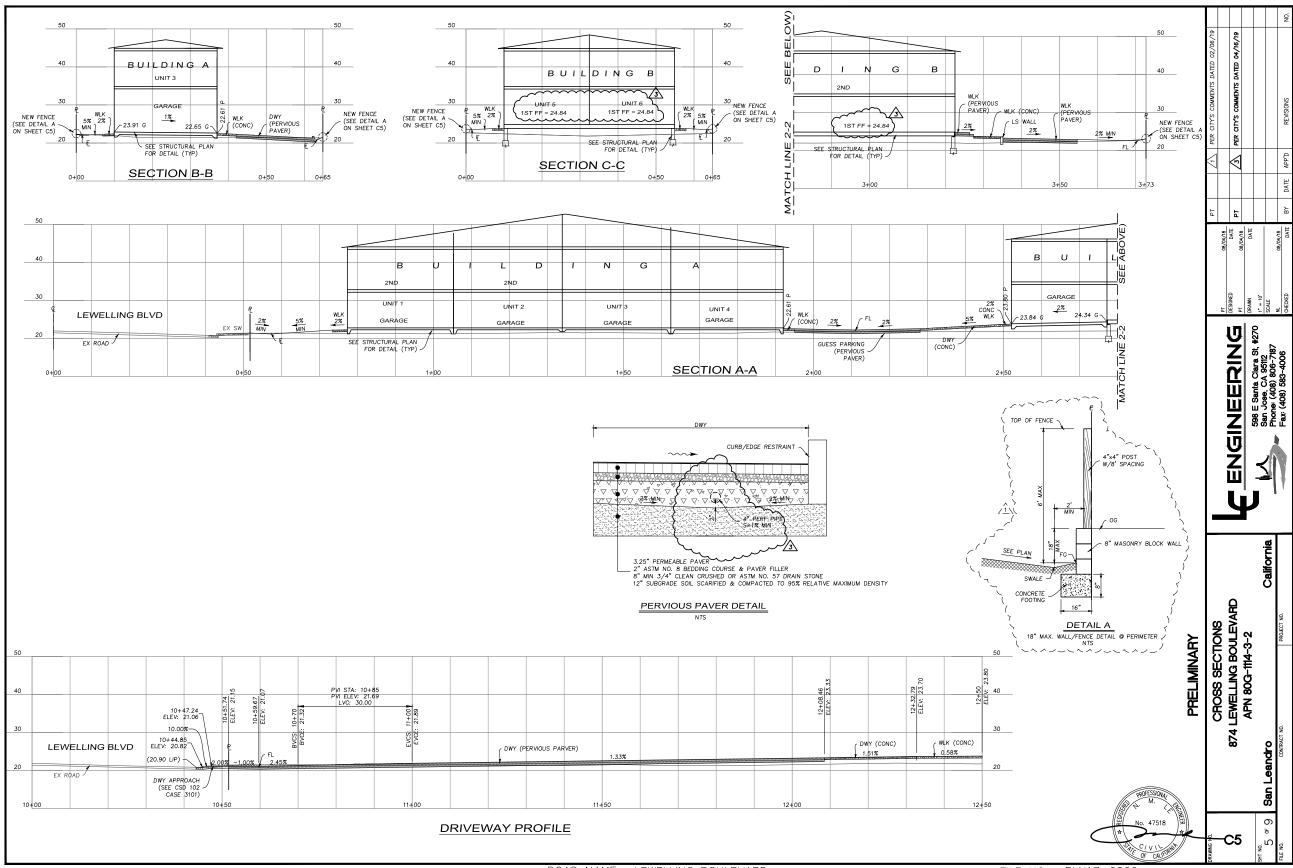

ROAD NAME : LEWELLING BOULEVARD


FILE NO : PLN17-0069

### **EXHIBIT R - UTILITY AND STRIPING PLAN**

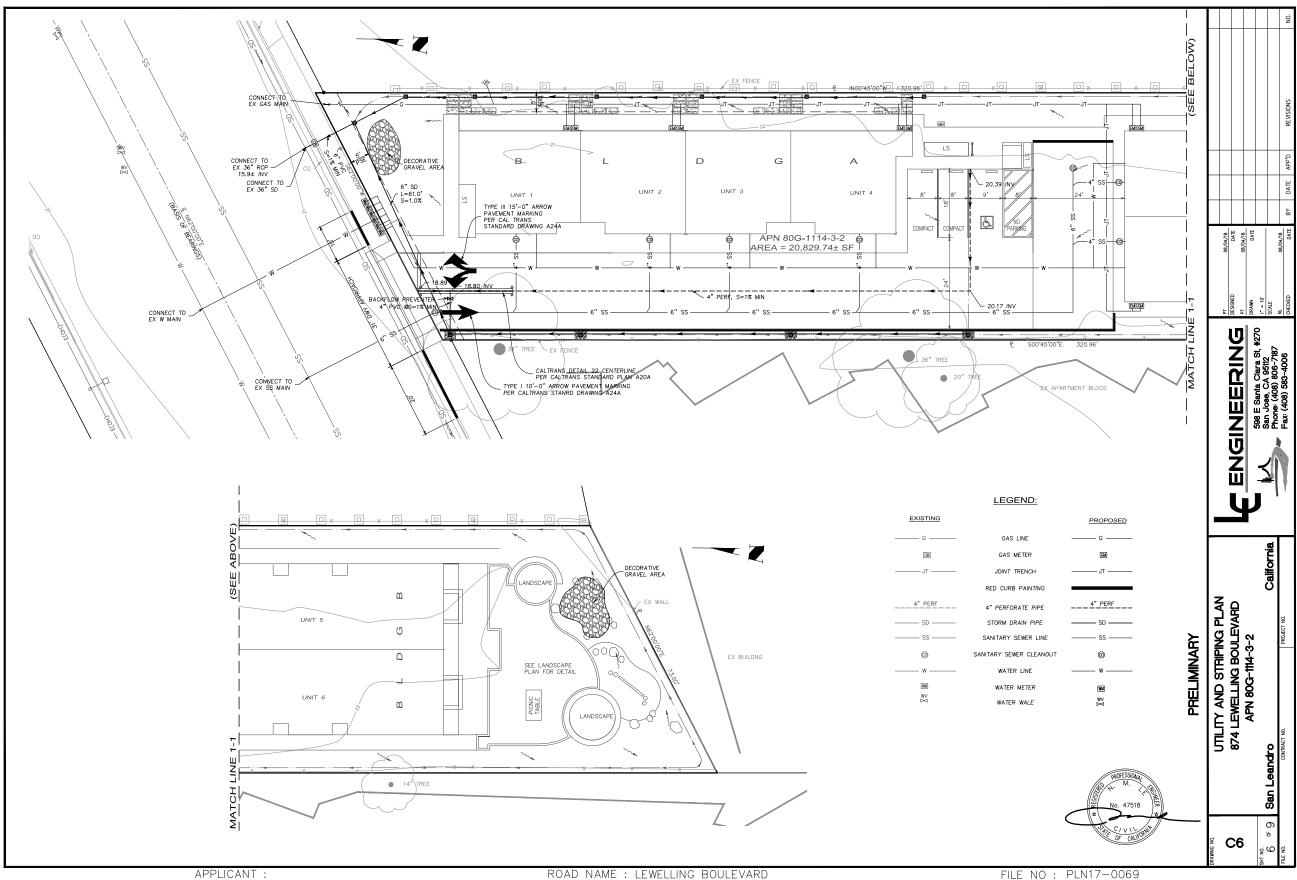

PLN17-0069 874 Lewelling Blvd - 6-Unit Townhome Development - Zoning Amendment, Planned Development, Site Plan Review, Tentative Map


### **EXHIBIT S - EROSION CONTROL PLAN**

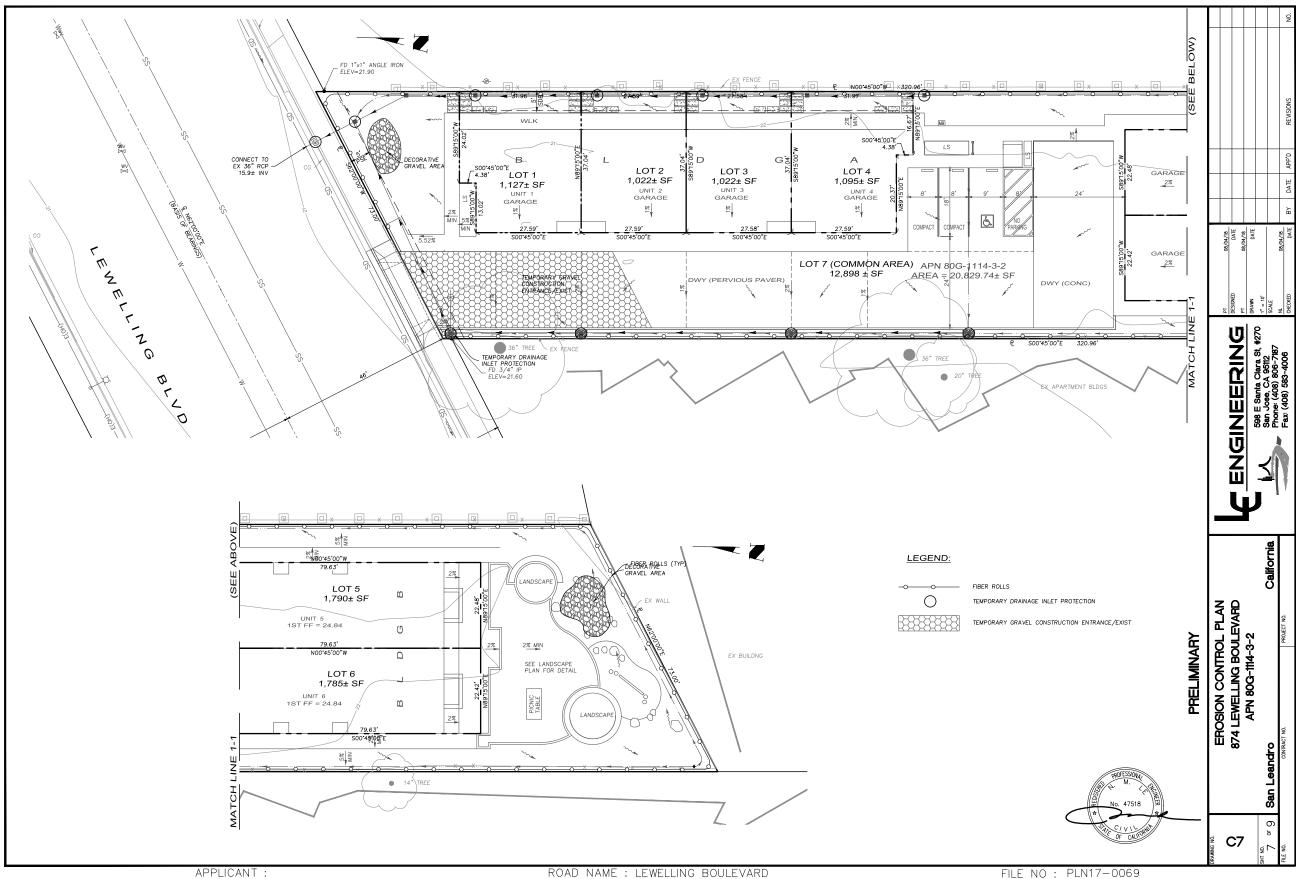

PLN17-0069 874 Lewelling Blvd - 6-Unit Townhome Development- Zoning Amendment, Planned Development, Site Plan Review, Tentative Map


FILE NO : PLN17-0069

#### **EXHIBIT T - STORMWATER BEST MANAGEMENT PRACTICES**

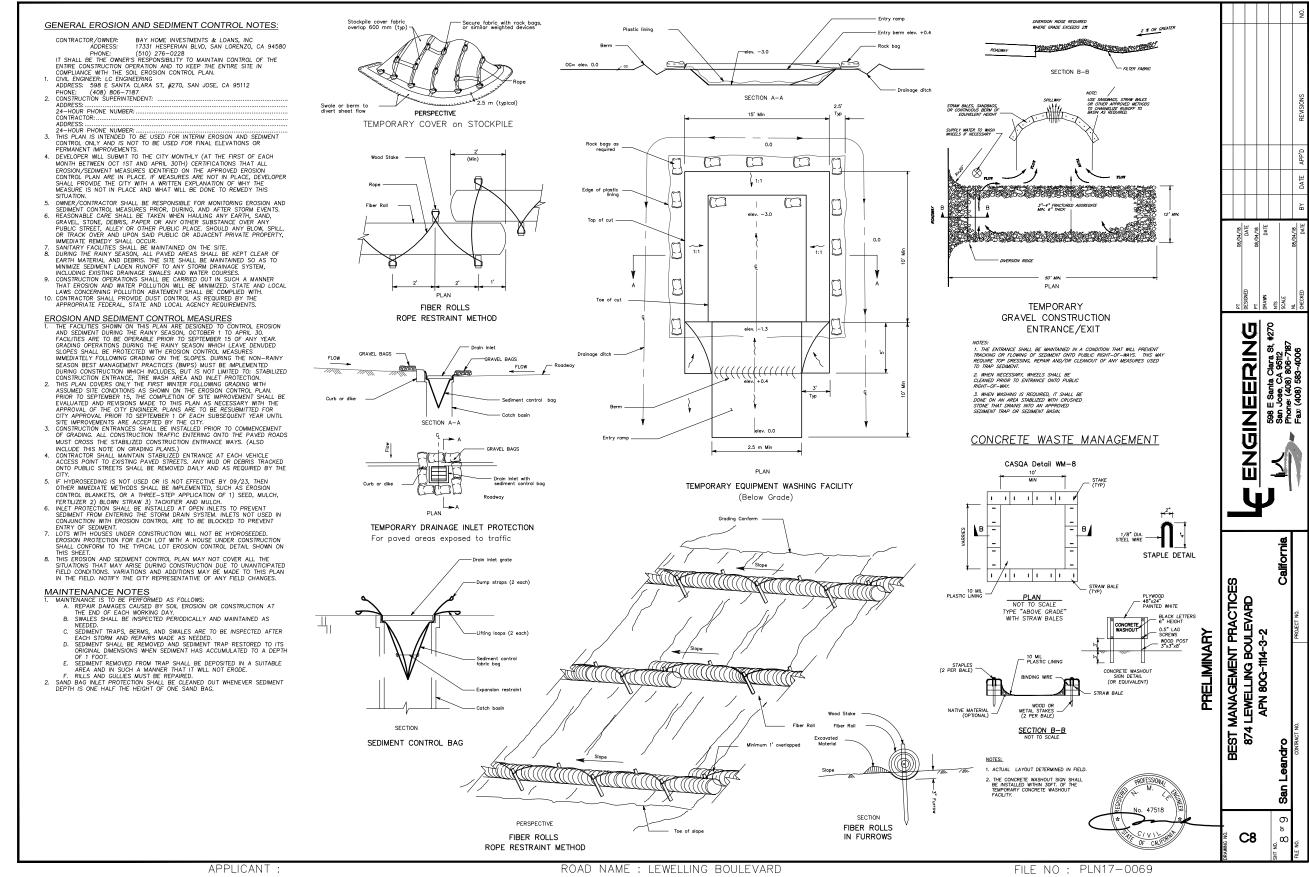


PLN17-0069 874 Lewelling Blvd - 6-Unit Townhome Development- Zoning Amendment, Planned Development, Site Plan Review, Tentative Map

#### **EXHIBIT U - LANDSCAPE PLAN**

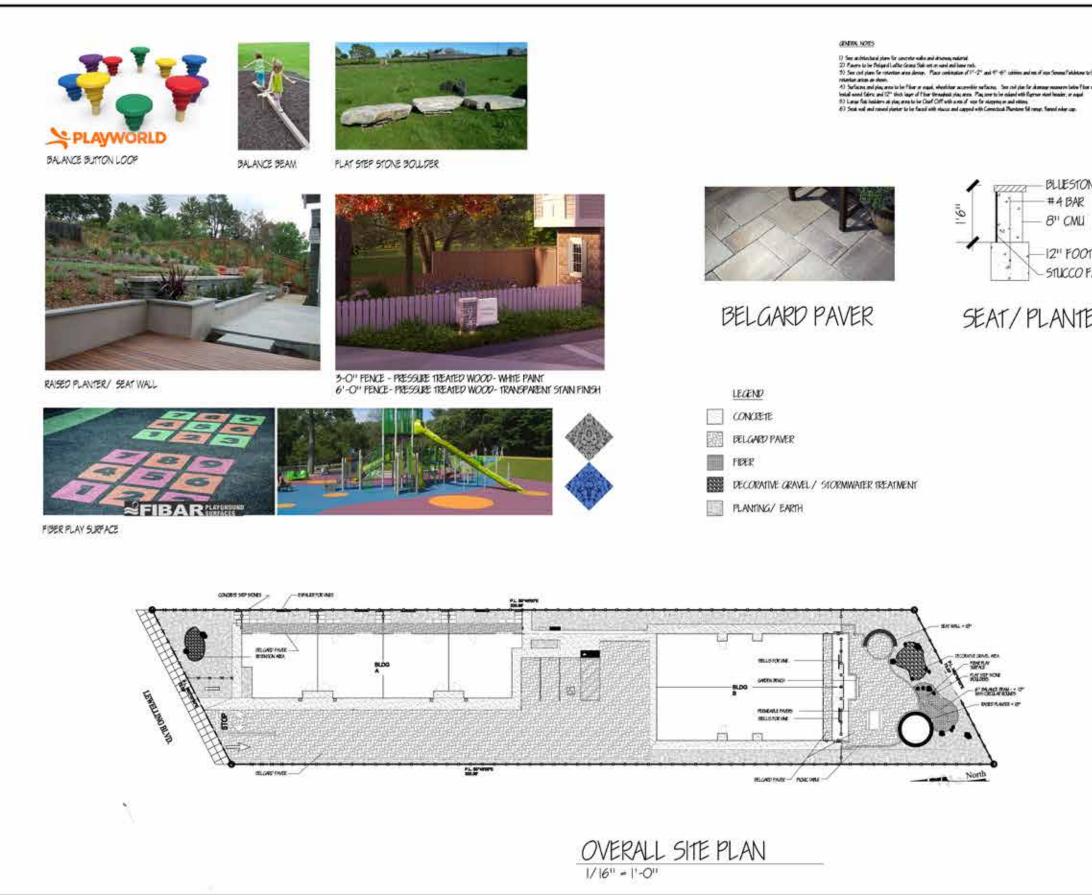

W. Jeffrey Held Landscape Architect 6179 Oreida Drive San Jose, California 95125 tal 408 691-5207 fm 408 226-6089 mai ajerdala@concast.o MERSHIP AND USE OF DRAMINS rgs, questioning and course. Survey, BLUESTONE CAP #4 BAR REVISED 7/30/18 8" CMU REVISED 8/6/18 REVISED 12/22/18 REVISED 5/10/19 12" FOOTING STUCCO FACE SEAT/PLANTER WALL LEWELLING CONDOMINIUMS for: BAY HOME INVESTMENTS AND LOANS, INC. 874 LEWELLING BLVD. SAN LEANDRO, CA. 94579 OVERALL SITE PLAN date: 7/19/18 scale: NOTED drawn by: WJH job no. 21837 sheet L 5 shts οĺ.

### **EXHIBIT V.1 - PLANTING**

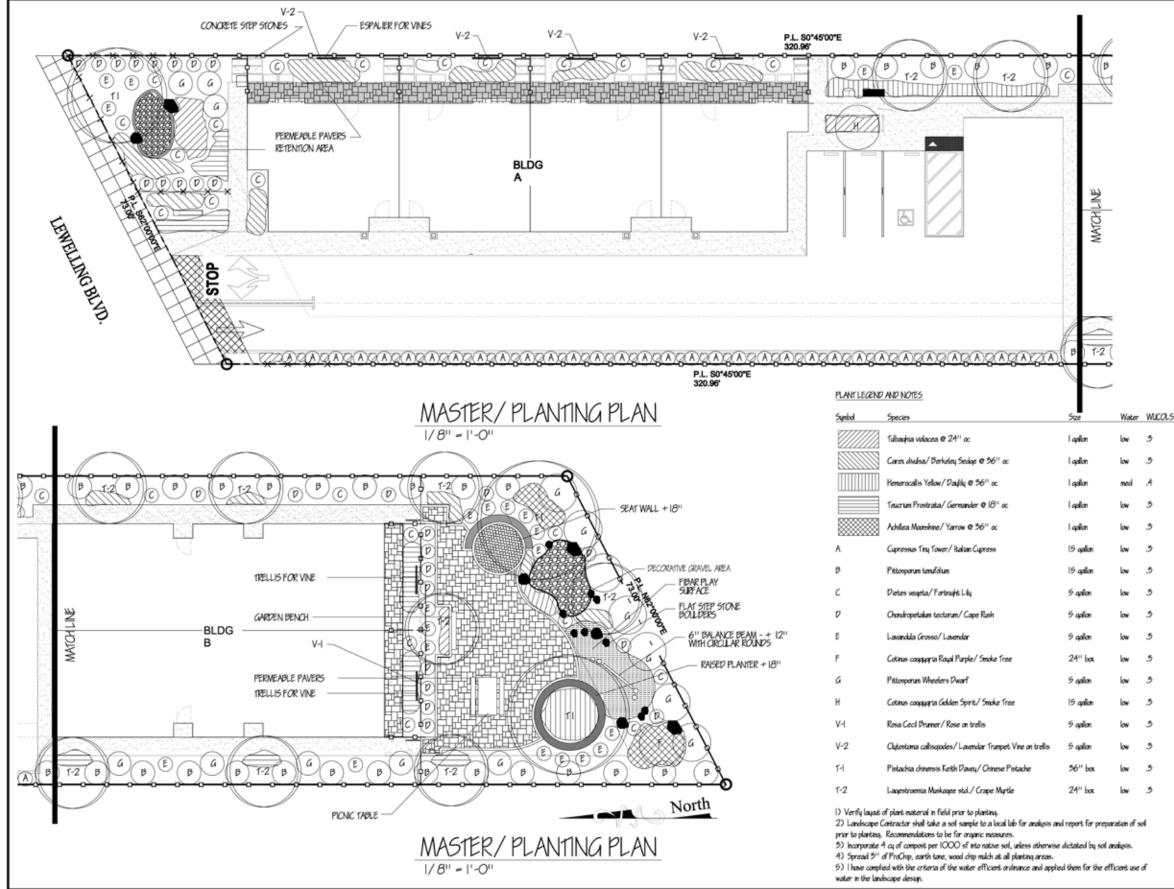

#### W. Jeffrey Heid Landscape Architect

6179 Oneida Drive San Jose, California 95125

tel 408 691-5207 fax 408 226-6085 mal vivrdada@co

WNERSHIP AND USE OF DRAWINGS whop, specifications and copies. Thereof furn frey field Landscape Architect are and shall n tp. They are to be used only with neapest to t and are not to be used on any other proje-ation or detribution to meet official regulatory

REVISED 7/30/18 REVISED 8/6/18 REVISED 12/22/18 REVISED 5/10/19



#### LEWELLING CONDOMINIUMS

for: BAY HOWE INVESTMENTS AND LOANS, INC. 874 LEWELLING BLVD. SAN LEANDRO, CA. 94579


MASTER PLANTING PLAN

date: 7/19/18 scale: NOTED drawn by: WJH job no. 21837 sheet

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#### **EXHIBIT V.2 - PHOTOS AND DETAILS**




PLN17-0069 874 Lewelling Blvd - 6-Unit Townhome Development- Zoning Amendment, Planned Development, Site Plan Review, Tentative Map

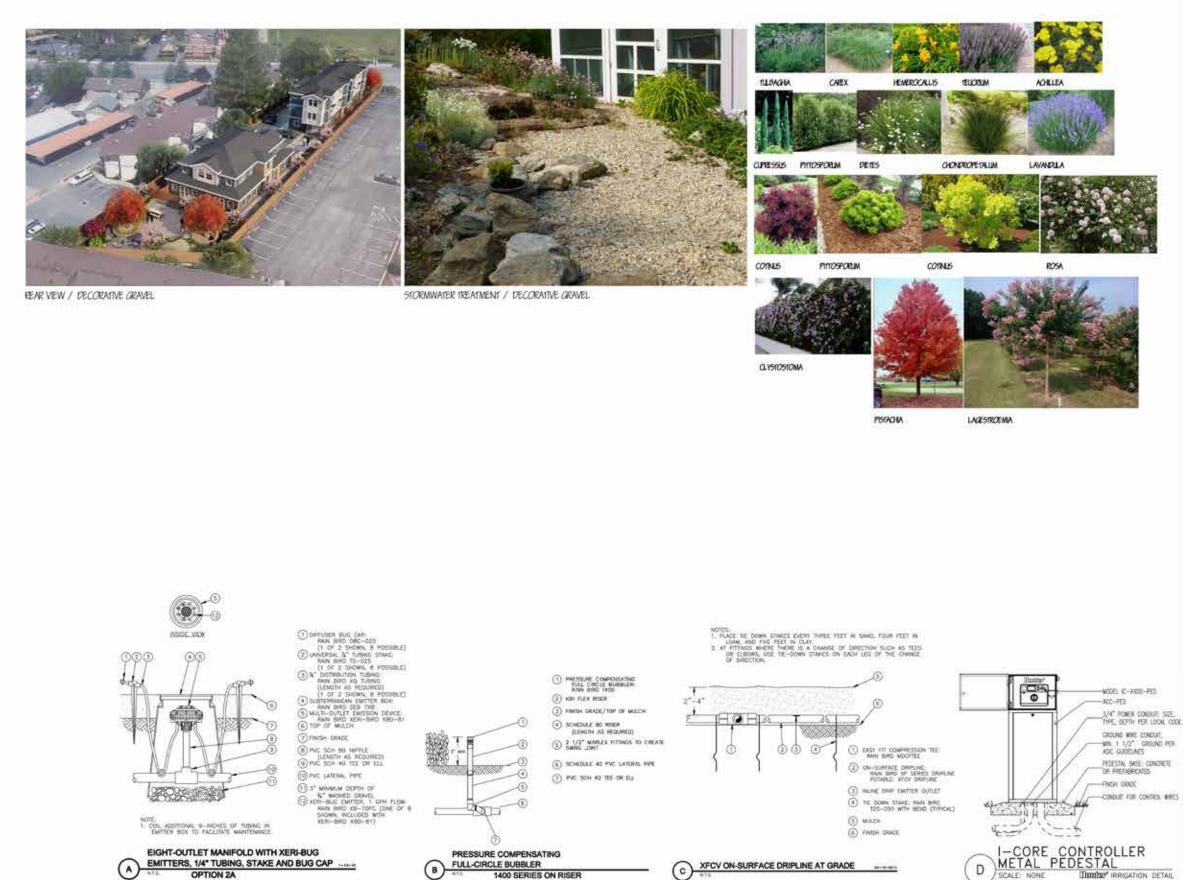W. Jeffrey Held Landscape Architect

6179 Oneida Drive San Jose, California 95125

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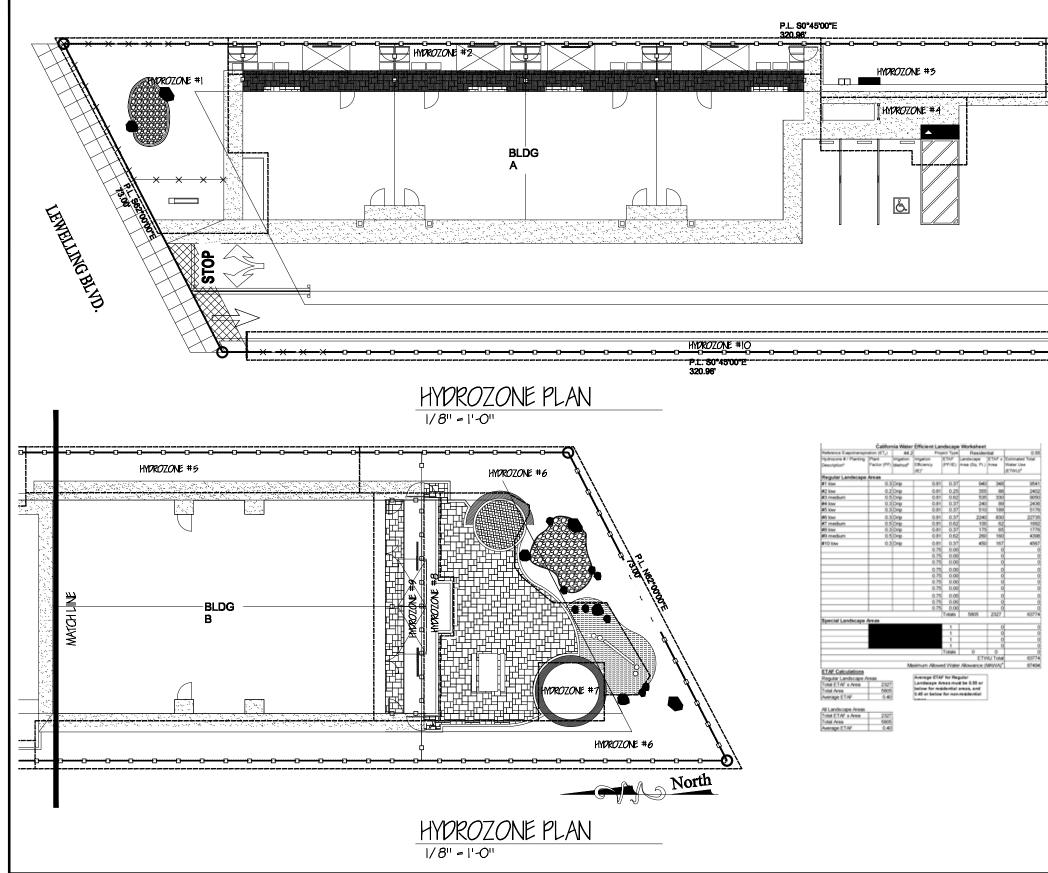
#### LEWELLING CONDOMINIUMS

tor BAY HOME INVESTMENTS AND LOANS, INC. 874 LEWELLING BLVD, SAN LEANDRO, CA. 94579

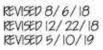PHOTOS AND DETAILS

date: 7/30/18 NOTED scale drawn by: WJH job no. 21837 sheet 5 L of 5 shts

#### **EXHIBIT W - HYDROZONE PLAN**





- Petrozone #7 Planting De 1.) Front lawn 2.) Low water use planting 3.) Medium water use plan
- Irrigation Method

Irrigation Efficiency 1.) 0.75 for Overhead Spray 2.) 0.81 for Drip

ETWU (Annual Gallons Rev Eto x 0.62 x ETAF x Area Where 0.12 is a conversion tac per year to gallons per square

 MWUA (Annual Gallons Allowed) = (Elto) (0.62) [ (ETAF x LA) + ((1-ETAF) x SLA Where G(2) is a conversion Sector to change acreper year to gallons per square floit per year, UA is the total

0.45	Non-Residential
0.55	Residential
0.81	Drip
0.75	Overhead

#### W. Jeffrey Heid Landscape Architect C-2235

6179 Oneida Drive San Jose, California 95123

tal 408 691-5207 fax 408 226-6085 nai wihsia

WNERSHIP AND USE OF DRAWINGS NI drawings, specifications and copies thereof furnished b N. Jeffrey Heid Landscape Architect are and shall remain i property. They are to be used only with respect to this project and are not to be used on any other project. Jubmission or distribution to meet official regulatory submission or distribution to meet official regule requirements or for other purposes in connection the Project is not to be construed as publication lerogation of W. Jeffrey Heid Landscape Architec common low constribution

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#### LEWELLING CONDOMINIUMS

for: BAY HOME INVESTMENTS AND LOANS, INC. 874 LEWELLING BLVD. SAN LEANDRO, CA. 94579


#### HYDROZONE PLAN

#### date: 1/25/18

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# **EXHIBIT X - IRRIGATION PLAN**



state circuite - one set inside drip tub
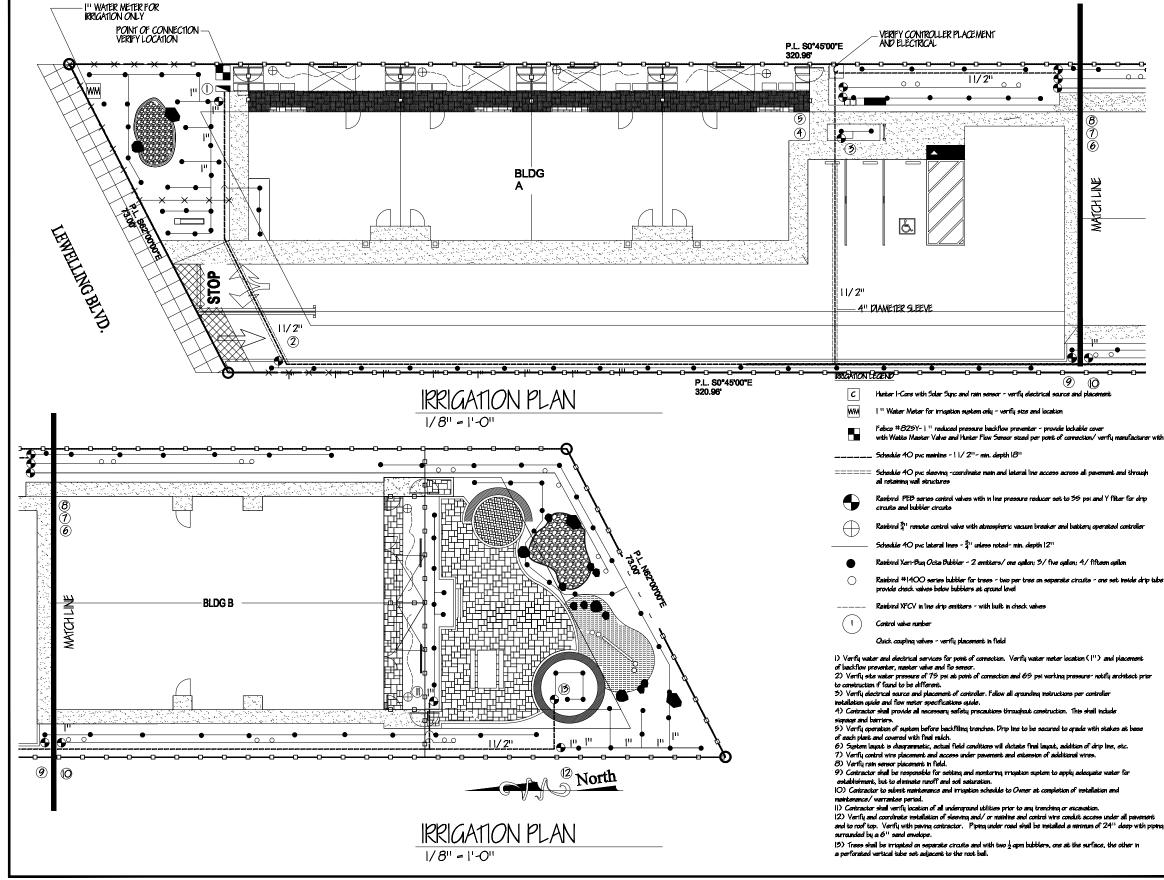
#### W. Jeffrey Heid Landscape Architect C-2235

6179 Oneida Drive San Jose, California 95123

tal 408 691-5207 fax 408 226-6085 mail wjheidasla@a

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#### LEWELLING CONDOMINIUMS

for: BAY HOME INVESTMENTS AND LOANS, INC. 874 LEWELLING BLVD. SAN LEANDRO, CA. 94579


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date: 1/30/18

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#### **EXHIBIT Y - LIGHTING PLAN**



### **EXHIBIT Z - SIDEWALK REPAIR EXHIBIT**

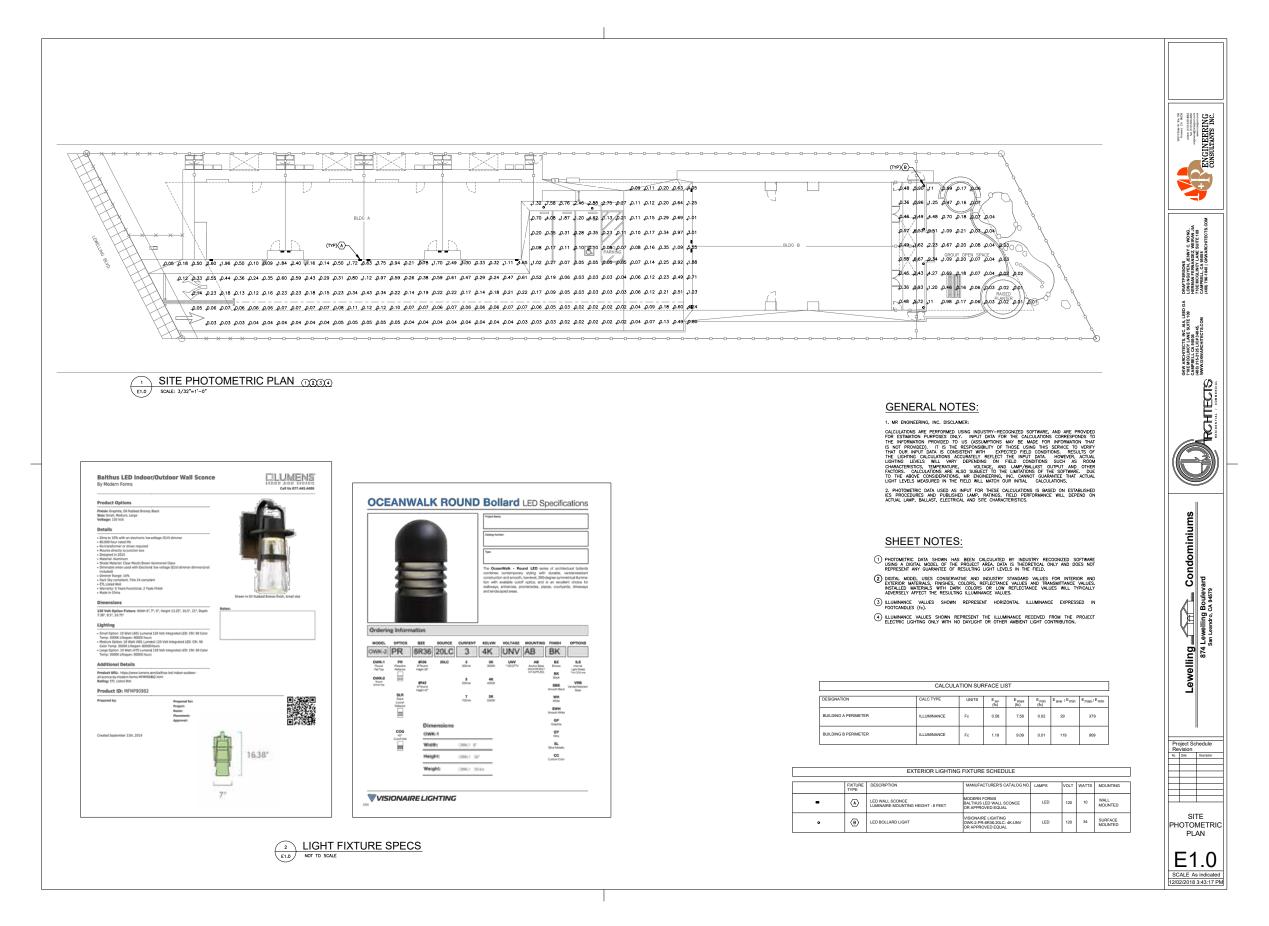

PLN17-0069 874 Lewelling Blvd - 6-Unit Townhome Development- Zoning Amendment, Planned Development, Site Plan Review, Tentative Map